



LEGEND	
EXISTING WALL	
NEW BRICK WALL	
NEW CONCRETE	
NEW DRYWALL	
DEMOLISHED WALL	

BUILDING CLASSIFICATION : H 4	REVISIONS	
COMPLIANCE IN RESPECT OF THE SOUTH AFRICAN NATIONAL BUILDING REGULATIONS AND BUILDIND STANDARDS ACT NO.103	NO. DATE REVISION	DRAWN
OF 1977		
PARTA : SANS10400- GENERAL PRINCIPLES & REQUIREMENTS All requirements to comply with part A		
PART B : SANS10400- STRUCTURAL DESIGN All structural design if not designed by a competent person		
shall comply with part B PART C : SANS10400- DIMENSIONS		
 All dimensions of any room or space to comply with requirements of part C 		
PARTD : SANS10400- PUBLIC SAFETY		
All balustrades to comply with part D 4.2 and annex A(D1) <u>PARTE : SANS10400- DEMOLISHED WORK</u>		
All demolished to comply with part E PART F : SANS10400- SITE OPERATIONS		
All site operations to comply with part F PART G : SANS10400- EXCAVATIONS		
 All excavations relating to building as per rational design by competent person to comply with part G 4.1 (b) 		
PARTH : SANS10400- FOUNDATIONS All foundations as per rational design by competent person to		
comply with part J 4.4.1(a) PART K : SANS10400- WALLS		
 All masonry walls as per rational design by competent person to comply with annex (K1, K2, K3, and K4) 		
 All lintols as per rational design by competent person to comply with annex (B3) 		
 All waterproofing to comply with part annex K 4.5 7 annex (C1) All fire performance & resistance of all walls as per rational 		
design by competent person to comply with annex A (k4) <u>PARTL : SANS10400- ROOFS</u>		
 All roof assemblies to comply with part L 4.1 (a) All flat concrete roof structure as per rational design and 		
 Certification by competent person All roof covering and waterproofing to pitched roof to comply 		
with part L4.5 All roof structure as per rational design and certification by		
approved competent person PART M : SANS10400- STAIRWAYS		
All stairways to comply with part M PARTN : SANS10400- GLAZING		
 All glazing to comply with part N 4.1, N4.2, N4.3 & N4.4 All glazing installations, windows systems and certification by 		
approved competent person. PART O : SANS10400- LIGHT AND VENTILLATION		
 All light and ventilation in compliance with part 04.1 All areas to have natural light in compliance with part 04.2.1 		
 All areas to have natural light in compliance with part 04.2.1 All areas to have natural ventilation in compliance with part P4.3.1 		
PARTP : SANS10400- DRAINAGE		
 All drainage to comply with annex A (P1 & P2) All material, piles, fittings and joints to comply with part P 4.2 All contrary furtures provided in compliance with part P 4.11 		
 All sanitary fixtures provided in compliance with part P 4.11 All sanitary ware fixtures provided in compliance with part P 4.3, 		
P4.4 & P4.6 □ All drainage system to comply with part P 4.13.2	CLIENT INFO.	
 All sizing of ventilation discharge pipes to comply with part P4.14 		
 All drain size shall comply with part P 4.15 All sanitary fixtures to be fitted with water seal traps in 	ADDRESS:	
 compliance with part P4.16 All sizing of ventilation pipe to comply with part P 4.17 	E-MAIL ADDRESS	
 All installations of discharge & ventilation pipes to be installed in compliance with part P 4.18 	SIGNATURE. :DATE	
 All drainage installation to accessible in compliance with part P4.19 	CLIENT INFO.	
 All traps to be provided in compliance with part P 4.20 All gullies provided in compliance with requirements of part 	NAME:	
P4.21 □ All drains to be laid in compliance with part P 4.22 & P4.23	ADDRESS:	
 All drains exceeding gradients of 1:5 shall have anchor blocks provided in place in compliance with part P 4.22.4 (D) 	TEL / CELL NO. :	
PARTR : SANS10400- STORMWATER DISPOSAL	E-MAIL ADDRESS :	
 All stormwater control and disposal to comply with part P 4.2 All sizes of roof valley & gutters as per rational design by 	CLIENT	
 competent person in compliance with part P 4.2 All stormwater drainage systems , layout and design as per 	×	
rational design by competent person .All installation and certifications thereof by approved registered		
competent plumbing specialist PARTT : SANS10400- FIRE PROTECTION		
 All materials to comply with part T 4.5 All structural elements & components to comply with part T 4.7 	The Game changer of South Coast development	
 Roof assemblies & covering to comply with part T 4.55 & T4.12 Building materials to comply with part T 4.55 & T4.56 		
PARTX : SANS10400- ENVIRONMENTAL SUSTAINABILITY & XA - ENERGY USAGE IN BUILDINGS		
Environmental sustainability and energy usage to comply with		
part X	we deliver innovative & cost effective solutions	
	ARCHITECT	
eel portal frame to	ARKITECX	
gineers detail	DESIGN INC.	
	registered architects, urban designers & development pl	lanners
	5, 13th AVENUE, UNIT 25 - 4C, FAIRLANDS, JOBURG, CELL 060 478 9391 CELL 0768564111 FAX 086 4	
	EMAIL: info@arkitecx.co.za	
	17 ANDERSON ROAD, UNIT 2, PINETOWN, DURBAN CELL 060 478 9391 CELL 067 210 4916 FAX 086 4 EMAIL: info@arkitecx.co.za	
0mm thick 700mm cover Newlok™ Dove Grey COLORPLUS® roof covering, fixed to steel purlins at 1900mm centres and end-	Author's Signature	
s at 1700mm centres (final spacing to be calculated by an	Mr G R Mzembe (Pr. Arch 53228341) SACAP	
sing Newlok™ clips secured to purlins with Fixtite® or Safintra vafer head self-tapping fasteners with roof insulation, all in	Project No: AKX 27 2022	
with the manufacturer`s recommendations @25 deg region: coastal belt		
ric corrosion category: C5.		ITY
	DEPOT SITE DESCRIPTION:	
	PORT SHEPSTONE , MARGATE KWAZULUNATAL	,
		М
gineers		
	JOB NUMBER AKX 27_2022 DRAWING NUMBER A1001 REV	V. NUMBER 0
S® nd-	DRAWN BY: KC (Psat) DATE: 2023/06/19 DW	/G STATUS
nd- an	CHECKED BY: GM (Pr.Arch) SCALE 1:100	
ntra In	ISSUED FOR INFORMATION	
	ISSUED FOR APPROVAL	
	ISSUED FOR TENDER	
	ISSUED FOR CONSTRUCTION	


170mm thick reinforced concrete roof slab with 4mm Derbigum dual reinforced waterproofing torch-on infusion on 30mm Cement-Sand screed ______ to lay on a gradiant of 1:100 fall to fullbore outlet in accordance to engineers detail and specification

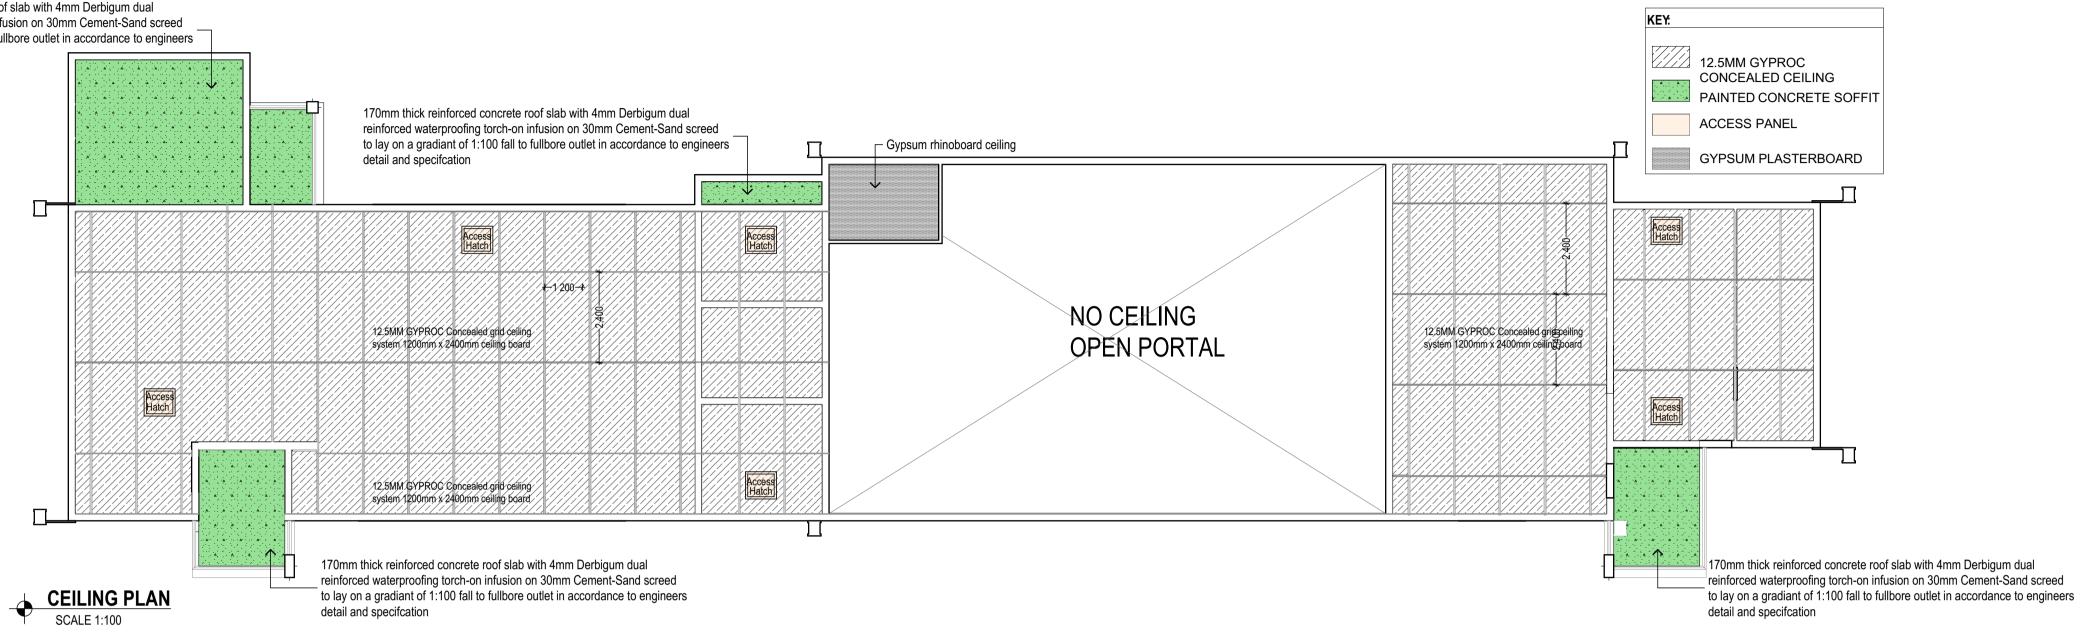

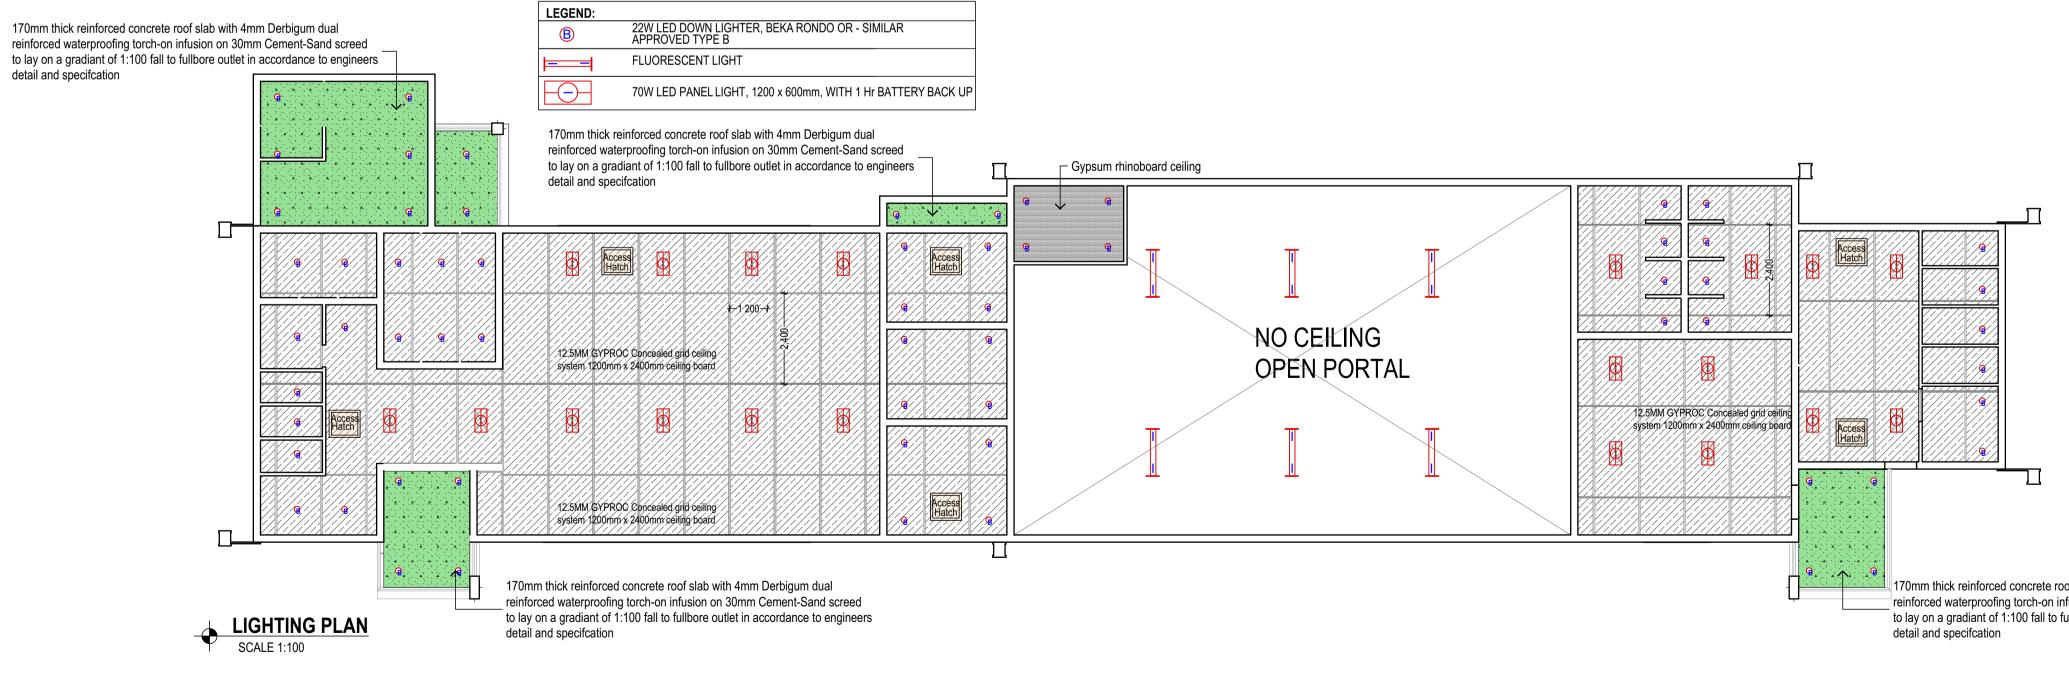


170mm thick reinforced concrete roof slab with 4mm Derbigum dual
 reinforced waterproofing torch-on infusion on 30mm Cement-Sand screed
 to lay on a gradiant of 1:100 fall to fullbore outlet in accordance to engineers
 detail and specification

BUILDING CLASSIFICATION : H4	REVISIONS NO. DATE REVISION DRAWN
COMPLIANCE IN RESPECT OF THE SOUTH AFRICAN NATIONAL BUILDING REGULATIONS AND BUILDIND STANDARDS ACT NO . 103	
PARTA : SANS10400- GENERAL PRINCIPLES & REQUIREMENTS All requirements to comply with part A	
PARTB : SANS10400- STRUCTURAL DESIGN All structural design if not designed by a competent person	
shall comply with part B PART C : SANS10400- DIMENSIONS	
All dimensions of any room or space to comply with	
requirements of part C PART D : SANS10400- PUBLIC SAFETY	
All balustrades to comply with part D 4.2 and annex A(D1) PARTE : SANS10400- DEMOLISHED WORK	
All demolished to comply with part E	
All site operations to comply with part F	
PART G : SANS10400- EXCAVATIONS All excavations relating to building as per rational design by	
competent person to comply with part G 4.1 (b) PART H : SANS10400- FOUNDATIONS	
 All foundations as per rational design by competent person to comply with part J4.4.1(a) 	
PARTK : SANS10400- WALLS	
 All masonry walls as per rational design by competent person to comply with annex (K1, K2, K3, and K4) 	
 All lintols as per rational design by competent person to comply with annex (B3) 	
 All waterproofing to comply with part annex K 4.5 7 annex (C1) All fire performance & resistance of all walls as per rational 	
design by competent person to comply with annex A(k4) PARTL :SANS10400- ROOFS	
All roof assemblies to comply with part L 4.1 (a)	
 All flat concrete roof structure as per rational design and certification by competent person 	
 All roof covering and waterproofing to pitched roof to comply with part L4.5 	
 All roof structure as per rational design and certification by approved competent person 	
PART M : SANS10400- STAIRWAYS All stairways to comply with part M	
PARTN : SANS10400- GLAZING	
 All glazing to comply with part N 4.1, N4.2, N4.3 & N4.4 All glazing installations, windows systems and certification by approved component parton. 	
approved competent person. <u>PART O : SANS10400- LIGHT AND VENTILLATION</u>	
 All light and ventilation in compliance with part 04.1 All areas to have natural light in compliance with part 04.2.1 	
 All areas to have natural ventilation in compliance with part P4.3.1 	
PARTP : SANS10400- DRAINAGE	
 All drainage to comply with annex A (P1 & P2) All material, piles, fittings and joints to comply with part P 4.2 	
 All sanitary fixtures provided in compliance with part P 4.11 All sanitary ware fixtures provided in compliance with part P 4.3, 	
 P4.4 & P4.6 All drainage system to comply with part P 4.13.2 	CLIENT INFO.
 All drainage system to comply with part P 4.13.2 All sizing of ventilation discharge pipes to comply with part P4.14 	NAME: RAY NKONYENI MUNICIPALITY
All drain size shall comply with part P 4.15	ADDRESS:
 All sanitary fixtures to be fitted with water seal traps in compliance with part P4.16 	TEL / CELL NO. :
 All sizing of ventilation pipe to comply with part P 4.17 All installations of discharge & ventilation pipes to be installed 	E-MAIL ADDRESS
in compliance with part P 4.18	SIGNATURE. :DATEDATE
P4.19	CLIENT INFO.
 All traps to be provided in compliance with part P 4.20 All gullies provided in compliance with requirements of part 	NAME:
P4.21All drains to be laid in compliance with part P 4.22 & P4.23	ADDRESS:
 All drains exceeding gradients of 1:5 shall have anchor blocks provided in place in compliance with part P 4.22.4 (D) 	TEL / CELL NO. :
PARTR : SANS10400- STORMWATER DISPOSAL	E-MAIL ADDRESS .:
 All stormwater control and disposal to comply with part P 4.2 All sizes of roof valley & gutters as per rational design by 	
 competent person in compliance with part P 4.2 All stormwater drainage systems , layout and design as per 	
rational design by competent person. All installation and certifications thereof by approved registered	
competent plumbing specialist	RAY NKONYENI
PARTT : SANS10400- FIRE PROTECTION All materials to comply with part T 4.5	MUNICIPALITY The Game changer of South Coast development
 All structural elements & components to comply with part T 4.7 Roof assemblies & covering to comply with part T 4.55 & T4.12 	PRINCIPAL AGENT
Building materials to comply with part T 4.55 & T4.56 PART X : SANS10400- ENVIRONMENTAL SUSTAINABILITY & XA	*
- ENERGY USAGE IN BUILDINGS	₩₽₽₽₽₽₽₽₽₽₽₽₽₽
 Environmental sustainability and energy usage to comply with part X 	ENGINEERING CONSULTANTS
· · · · · · · · · · · · · · · · · · ·	we deliver innovative & cost effective solutions
	ARCHITECT
	ARKITECX
	DESIGN
	INC. registered architects, urban designers & development planners
	5, 13th AVENUE, UNIT 25 - 4C, FAIRLANDS, JOBURG, 2195
	5, 130 AVENUE, UNI 25 - 40, PAIRLANDS, JOBURG, 2195 CELL 060 478 9391 CELL 0768564111 FAX 086 436 7841 EMAIL: info@arkitecx.co.za
	17 ANDERSON ROAD, UNIT 2, PINETOWN, DURBAN, 3600 CELL 060 478 9391 CELL 067 210 4916 FAX 086 436 7841
	EMAIL: info@arkitecx.co.za
	Author's Signature
	Mr G R Mzembe (Pr. Arch 53228341) SACAP
	Project No: AKX 27_2022
	RAY NKONYENI MUNICIPALITY DEPOT
	SITE DESCRIPTION:
	PORT SHEPSTONE , MARGATE, KWAZULUNATAL
	DESCRIPTION: WORKSHOP / CHANGEROOM CEILING
	PLAN + LIGHTING PLAN
	JOB NUMBER DRAWING NUMBER REV. NUMBER
	AKX 27_2022 A1002 0
	DRAWN BY: KC (Psat) DATE: 2023/06/19 CHECKED BY: CM (Ps Assb) Scott = 1:100
	CHECKED BY: GM (Pr.Arch) SCALE 1:100
	ISSUED FOR INFORMATION
	ISSUED FOR APPROVAL
	ISSUED FOR SUBMISSION
	ISSUED FOR TENDER
	ISSUED FOR CONSTRUCTION

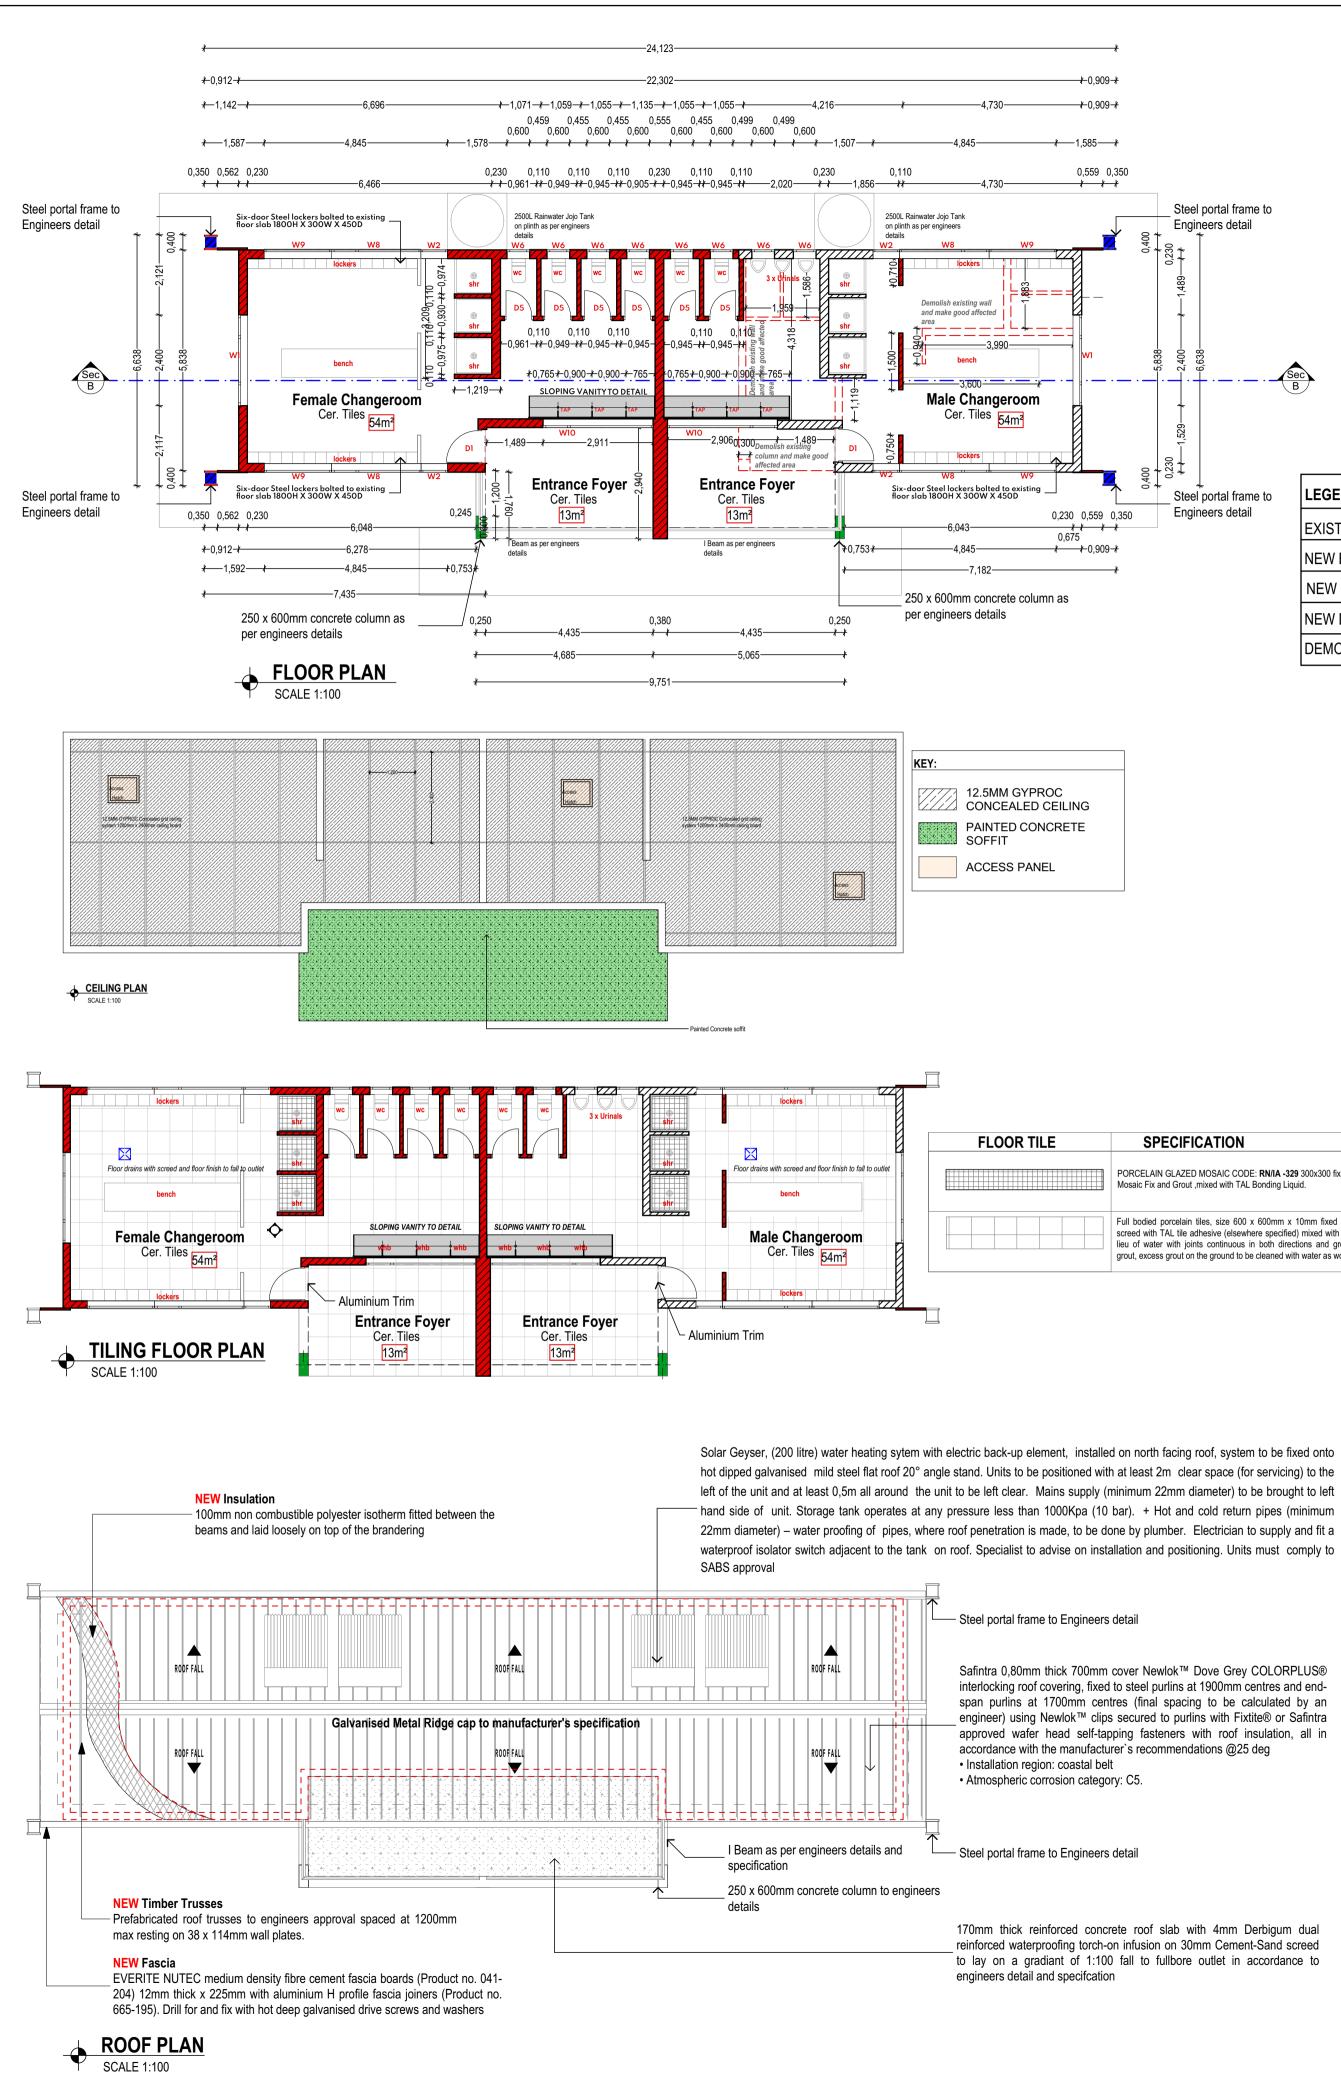


GENERAL NOTES: ALL DIMENSIONS MUST BE VERIFIED/CHECKED ON SITE. SHOP DRAWINGS TO BE SUBMITTED TO ARCHITECT FOR APPROVAL. ALL DRAWINGS TO BE READ IN CONJUCTION WITH THE GENERAL SPECIFICATION AND FINISHES SCHEDULE.

LEGEND	
EXISTING WALL	
NEW BRICK WALL	
NEW CONCRETE	
NEW DRYWALL	
DEMOLISHED WALL	

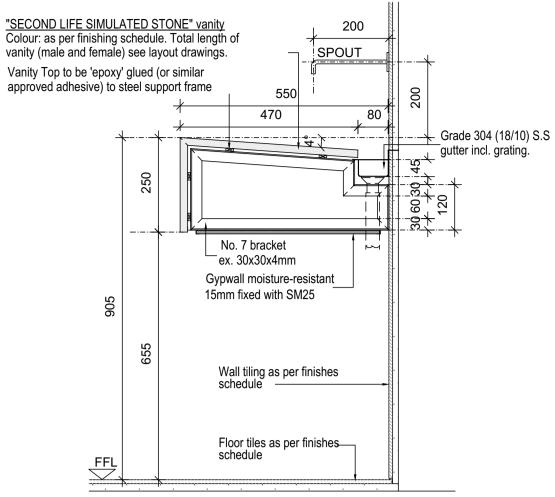

SCALE 1:10

D

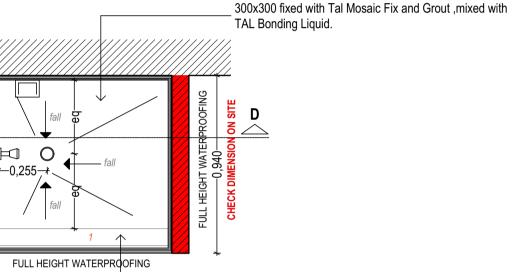

- 170mm Dwarf cubicle wall

with water as work proceeds

TAL Bonding Liquid.

with fall towards outlet.

walls

PORCELAIN GLAZED MOSAIC CODE: RN/IA -329

Full bodied polished porcelain tiles, size 300 x 600mm x 10mm fixed to internal wall plaster backing with TAL tile

adhesive (elsewhere specified) mixed with TAL bonding in

lieu of water with continuous in both directions and grouted

with TAL grout, excess grout on the ground to be cleaned

PORCELAIN GLAZED MOSAIC CODE: RN/IA -329

300x300 fixed with Tal Mosaic Fix and Grout ,mixed with

Apply "CEMFLEX" [or equally approved] waterproofing to

slab and plastered walls as shown. "CEMFLEX" [or equally

approved] waterproofing taken up full height on shower

Screed shower floor as indicated, min. thickness 30mm,



Δ. Δ. Δ. Δ.

CHECK DIMENSION ON SITE

screed 🔨

Concrete slab

PORCELAIN GLAZED MOSAIC CODE: RN/IA -329 300x300 fixed with Tal

Full bodied porcelain tiles, size 600 x 600mm x 10mm fixed to internal floor screed with TAL tile adhesive (elsewhere specified) mixed with TAL bonding in lieu of water with joints continuous in both directions and grouted with TAL grout, excess grout on the ground to be cleaned with water as work proceeds


Apply "CEMFLEX" [or equally approved] waterproofing incl. "CEMFLEX" [or equally approved] membrane as per Manufacturers specification to screed, overlap existing & dress around head of trap


Place "COBRA" 373SQ shower trap into position & connect ____ to HDPE waste pipe [similar or equally approved]

Apply "CEMFLEX" [or equally approved] waterproofing to slab and plastered walls as shown. "CEMFLEX" [or equally approved] waterproofing taken up full height on shower walls

TYPICAL SHOWER SECTION DETAIL SCALE 1:10



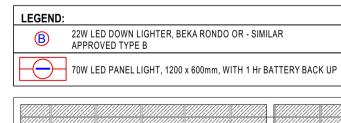

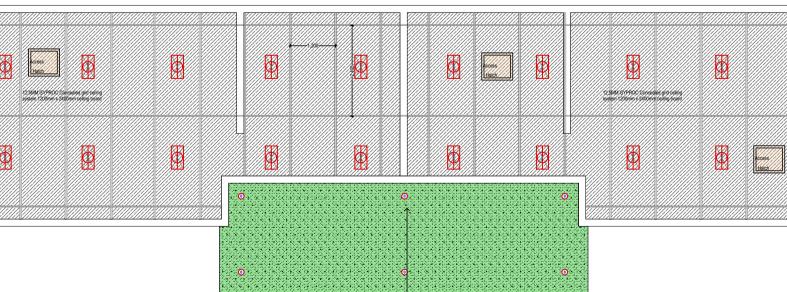




	1
<u>BUILDING CLASSIFICATION : H4</u> COMPLIANCE IN RESPECT OF THE SOUTH AFRICAN NATIONAL	REVISIONS NO. DATE REVISION DRAWN
BUILDING REGULATIONS AND BUILDIND STANDARDS ACT NO . 103 OF 1977	
PARTA : SANS10400- GENERAL PRINCIPLES & REQUIREMENTS All requirements to comply with part A	
PART B : SANS10400- STRUCTURAL DESIGN All structural design if not designed by a competent person	
shall comply with part B PART C : SANS10400- DIMENSIONS	
 All dimensions of any room or space to comply with requirements of part C PARTD : SANS10400- PUBLIC SAFETY 	
All balustrades to comply with part D 4.2 and annex A(D1) <u>PARTE : SANS10400- DEMOLISHED WORK</u>	
All demolished to comply with part E PARTF : SANS10400- SITE OPERATIONS	
 All site operations to comply with part F <u>PART G</u>: <u>SANS10400-</u> EXCAVATIONS All excavations relating to building as per rational design by 	
competent person to comply with part G 4.1 (b) <u>PARTH</u> : SANS10400- FOUNDATIONS	
 All foundations as per rational design by competent person to comply with part J 4.4.1(a) PARTK : SANS10400- WALLS 	
 All masonry walls as per rational design by competent person to comply with annex (K1, K2, K3, and K4) 	
 All lintols as per rational design by competent person to comply with annex (B3) All waterproofing to comply with part annex K 4.5 7 annex (C1) 	
 All fire performance & resistance of all walls as per rational design by competent person to comply with annex A (k4) 	
 <u>PARTL</u>: <u>SANS10400- ROOFS</u> All roof assemblies to comply with part L 4.1 (a) All flat concrete roof structure as per rational design and 	
 certification by competent person All roof covering and waterproofing to pitched roof to comply 	
 with part L4.5 All roof structure as per rational design and certification by approved competent person 	
PART M : SANS10400- STAIRWAYS All stairways to comply with part M	
 <u>PART N : SANS10400- GLAZING</u> All glazing to comply with part N 4.1, N4.2, N4.3 & N4.4 All glazing installations, windows systems and certification by 	
approved competent person . PART O : SANS10400- LIGHT AND VENTILLATION	
 All light and ventilation in compliance with part 04.1 All areas to have natural light in compliance with part 04.2.1 All areas to have natural ventilation in compliance with part 	
All areas to have natural ventilation in compliance with part P4.3.1 PART P : SANS10400- DRAINAGE	
 All drainage to comply with annex A (P1 & P2) All material, piles, fittings and joints to comply with part P 4.2 	
 All sanitary fixtures provided in compliance with part P 4.11 All sanitary ware fixtures provided in compliance with part P 4.3, P4.4 & P4.6 	
 All drainage system to comply with part P 4.13.2 All sizing of ventilation discharge pipes to comply with part 	CLIENT INFO. NAME: RAY NKONYENI MUNICIPALITY
 P4.14 All drain size shall comply with part P 4.15 All sanitary fixtures to be fitted with water seal traps in 	ADDRESS:
 All sampliance with part P 4.16 All sizing of ventilation pipe to comply with part P 4.17 	TEL / CELL NO. :
 All installations of discharge & ventilation pipes to be installed in compliance with part P 4.18 All drainage installation to accessible in compliance with part 	SIGNATURE. :
 P4.19 All traps to be provided in compliance with part P 4.20 	CLIENT INFO.
 All gullies provided in compliance with requirements of part P4.21 All drains to be laid in compliance with part P 4.22 & P4.23 	ADDRESS:
 All drains to be late in compliance with part 1 4.22 of 4.25 All drains exceeding gradients of 1:5 shall have anchor blocks provided in place in compliance with part P 4.22.4 (D) 	TEL / CELL NO. :
PART R : SANS10400- STORMWATER DISPOSAL All stormwater control and disposal to comply with part P 4.2	SIGNATURE. :
 All sizes of roof valley & gutters as per rational design by competent person in compliance with part P 4.2 All stormwater drainage systems, layout and design as per 	CLIENT
rational design by competent person .All installation and certifications thereof by approved registered	
competent plumbing specialist <u>PARTT : SANS10400- FIRE PROTECTION</u> All materials to comply with part T 4.5	
 All structural elements & components to comply with part T 4.7 Roof assemblies & covering to comply with part T 4.55 & T4.12 	The Game changer of South Coast development PRINCIPAL AGENT
Building materials to comply with part T 4.55 & T4.56 <u>PARTX : SANS10400- ENVIRONMENTAL SUSTAINABILITY & XA</u>	TT DCN
 <u>- ENERGY USAGE IN BUILDINGS</u> Environmental sustainability and energy usage to comply with part X 	ENGINEERING
· ·	we deliver innovative & cost effective solutions
	ARKITECX
	DESIGN INC.
	registered architects, urban designers & development planners
	5, 13th AVENUE, UNIT 25 - 4C, FAIRLANDS, JOBURG, 2195 CELL 060 478 9391 CELL 0768564111 FAX 086 436 7841 EMAIL: info@arkitecx.co.za
	17 ANDERSON ROAD, UNIT 2, PINETOWN, DURBAN, 3600 CELL 060 478 9391 CELL 067 210 4916 FAX 086 436 7841 EMAIL: info@arkitecx.co.za
	Author's Signature
	Mr G R Mzembe (Pr. Arch 53228341) SACAP
	Project No: AKX 27_2022
	RAY NKONYENI MUNICIPALITY DEPOT
	DEPOT SITE DESCRIPTION: PORT SHEPSTONE , MARGATE,
	KWAZULUNATAL
	DESCRIPTION: ROADS DEPARTMENT_MALE + FEMALE CHANGEROOM _FLOORPLANS
	JOB NUMBER AKX 27_2022 DRAWING NUMBER A1003 0
	DRAWN BY: KC (Psat) DATE: 2023/06/19 CHECKED BY: GM (Pr.Arch) SCALE 1:100
	ISSUED FOR INFORMATION
	ISSUED FOR APPROVAL
	ISSUED FOR TENDER


ISSUED FOR CONSTRUCTION




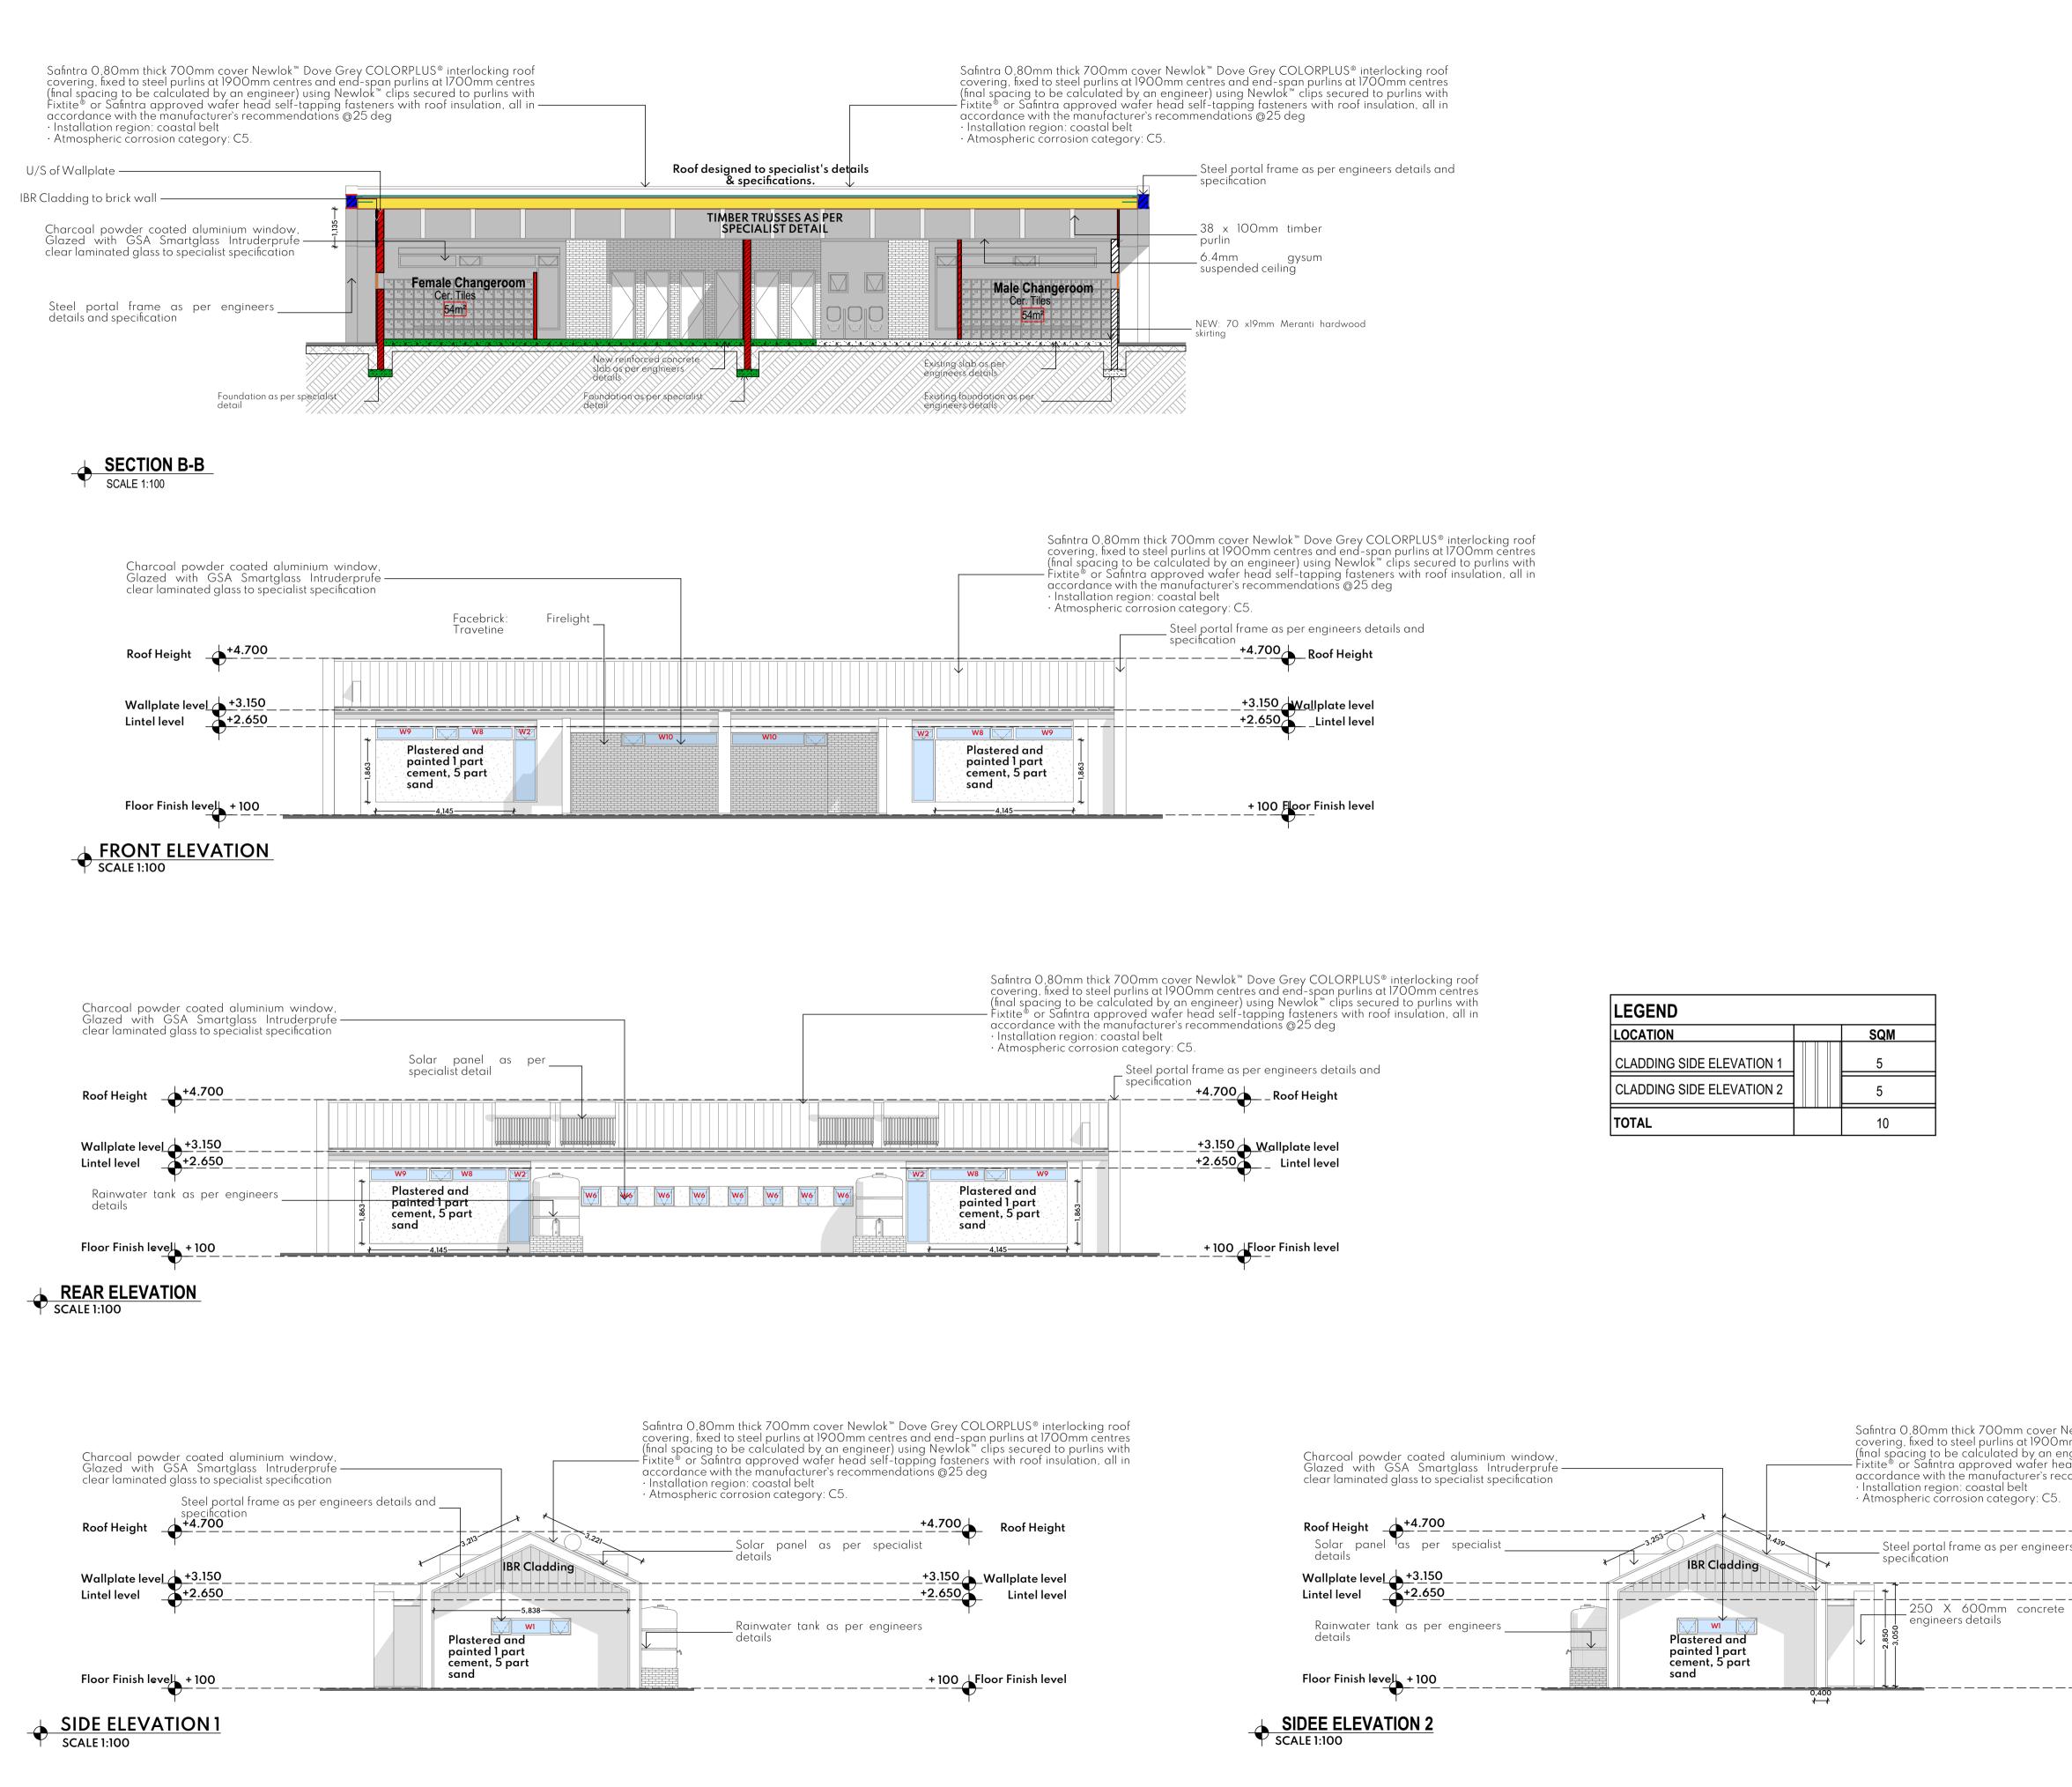

LEGEND					
LOCATION			_	SQM	
CLADDING SIDE ELEVATION 1				5	
CLADDING SIDE ELEVATION 2				5	
TOTAL				10	


BUILDING CLASSIFICATION : H 4	REVISIONS
COMPLIANCE IN RESPECT OF THE SOUTH AFRICAN NATIONAL	NO. DATE REVISION DRAWN
BUILDING REGULATIONS AND BUILDIND STANDARDS ACT NO. 103 OF 1977	
PARTA : SANS10400- GENERAL PRINCIPLES & REQUIREMENTS	
All requirements to comply with part A PART B : SANS10400- STRUCTURAL DESIGN	
 All structural design if not designed by a competent person shall comply with part B 	
PARTC : SANS10400- DIMENSIONS	
 All dimensions of any room or space to comply with requirements of part C PARTD : SANS10400- PUBLIC SAFETY 	
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PART F : SANS10400- SITE OPERATIONS All site operations to comply with part F	
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 All fire performance & resistance of all walls as per rational design by competent person to comply with annex A (k4) 	
PARTL : SANS10400- ROOFS All roof assemblies to comply with part L 4.1 (a)	
 All flat concrete roof structure as per rational design and certification by competent person 	
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PART M : SANS10400- STAIRWAYS All stairways to comply with part M	
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PART O : SANS10400- LIGHT AND VENTILLATION All light and ventilation in compliance with part 04.1	
 All areas to have natural light in compliance with part 04.2.1 All areas to have natural ventilation in compliance with part 	
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 All drainage to comply with annex A (P1 & P2) All material, piles, fittings and joints to comply with part P 4.2 	
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 All games provided in compliance with requirements of part P4.21 All drains to be laid in compliance with part P 4.22 & P4.23 	ADDRESS:
All drains exceeding gradients of 1:5 shall have anchor blocks	TEL / CELL NO . :
provided in place in compliance with part P 4.22.4 (D) <u>PARTR</u> : SANS10400- STORMWATER DISPOSAL	E-MAIL ADDRESS
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competent plumbing specialist PARTT : SANS10400- FIRE PROTECTION	
 All materials to comply with part T 4.5 All structural elements & components to comply with part T 4.7 	The Game changer of South Coast development
 Roof assemblies & covering to comply with part T 4.55 & T4.12 Building materials to comply with part T 4.55 & T4.56 	PRINCIPAL AGENT
PARTX : SANS10400- ENVIRONMENTAL SUSTAINABILITY & XA - ENERGY USAGE IN BUILDINGS	T RCN
 Environmental sustainability and energy usage to comply with part X 	ENGINEERING CONSULTANTS
	we deliver innovative & cost effective solutions
	ARCHITECT
	ARKITECX
	DESIGN INC.
	registered architects, urban designers & development planners
	5, 13th AVENUE, UNIT 25 - 4C, FAIRLANDS, JOBURG, 2195 CELL 060 478 9391 CELL 0768564111 FAX 086 436 7841
	EMAIL: info@arkitecx.co.za 17 ANDERSON ROAD, UNIT 2, PINETOWN, DURBAN, 3600
	CELL 060 478 9391 CELL 067 210 4916 FAX 086 436 7841 EMAIL: info@arkitecx.co.za
	Author's Signature
	Mr G R Mzembe (Pr. Arch 53228341) SACAP
	Project No: AKX 27_2022
lewlok™ Dove Grey COLORPLUS® interlocking roof	
im centres and end-span purlins at 1700mm centres igineer) using Newlok™ clips secured to purlins with ad self-tapping fasteners with roof insulation, all in	RAY NKONYENI MUNICIPALITY DEPOT
ommendations @25 deg	SITE DESCRIPTION:
	PORT SHEPSTONE , MARGATE, KWAZULUNATAL
+4.700 Roof Height	DESCRIPTION:
's details and	ROADS DEPARTMENT_MALE + FEMALE CHANGEROOM _SECTION + ELEVATIONS
+3.150 Wallplate level +2.650 Lintel level	
+2.650	JOB NUMBER DRAWING NUMBER REV. NUMBER AKX 27_2022 A2002 0
	DRAWN BY: KC (Psat) DATE: 2023/06/19 DWG STATUS
	CHECKED BY: GM (Pr.Arch) SCALE 1:100
+ 100 Floor Finish level	
$\mathbf{\Psi}$	ISSUED FOR APPROVAL
	ISSUED FOR TENDER
	ISSUED FOR CONSTRUCTION

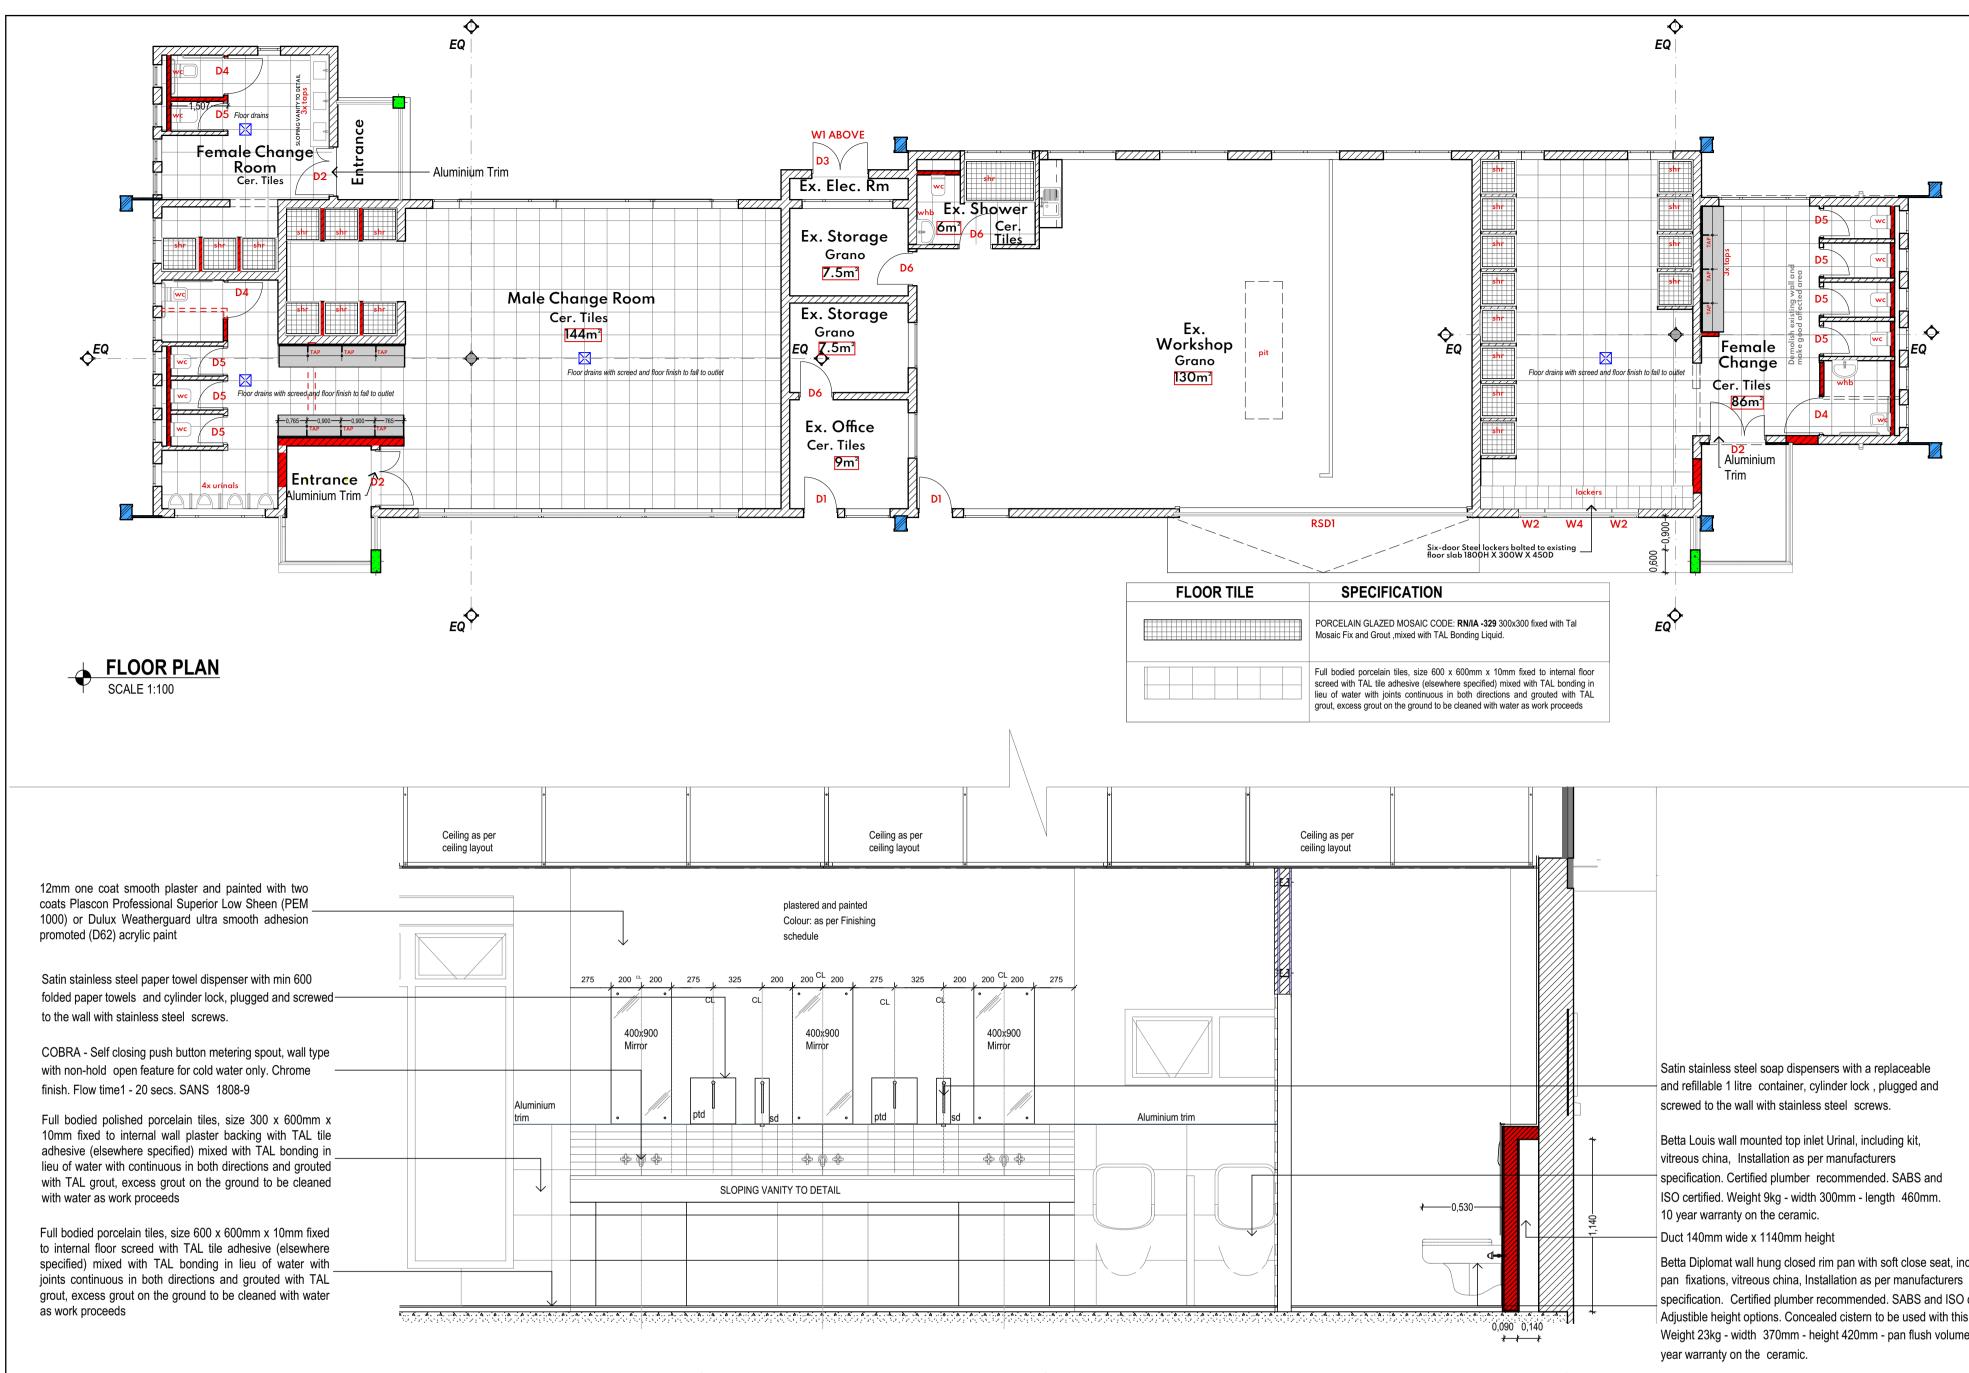


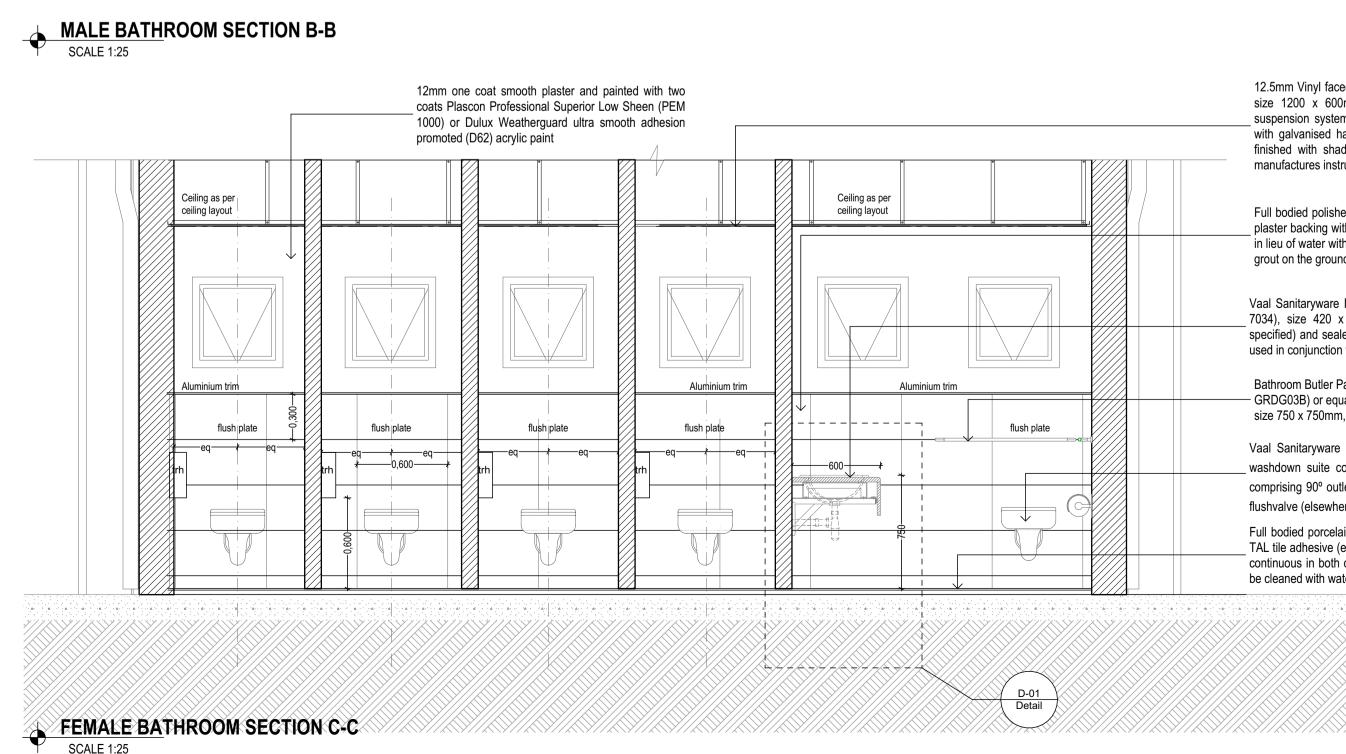



Betta Diplomat wall hung closed rim pan with soft close seat, including specification. Certified plumber recommended. SABS and ISO certified. Adjustible height options. Concealed cistern to be used with this pan. Pan Weight 23kg - width 370mm - height 420mm - pan flush volume 3/6 Lt, 10


GENERAL NOTES: SCHEDULE.

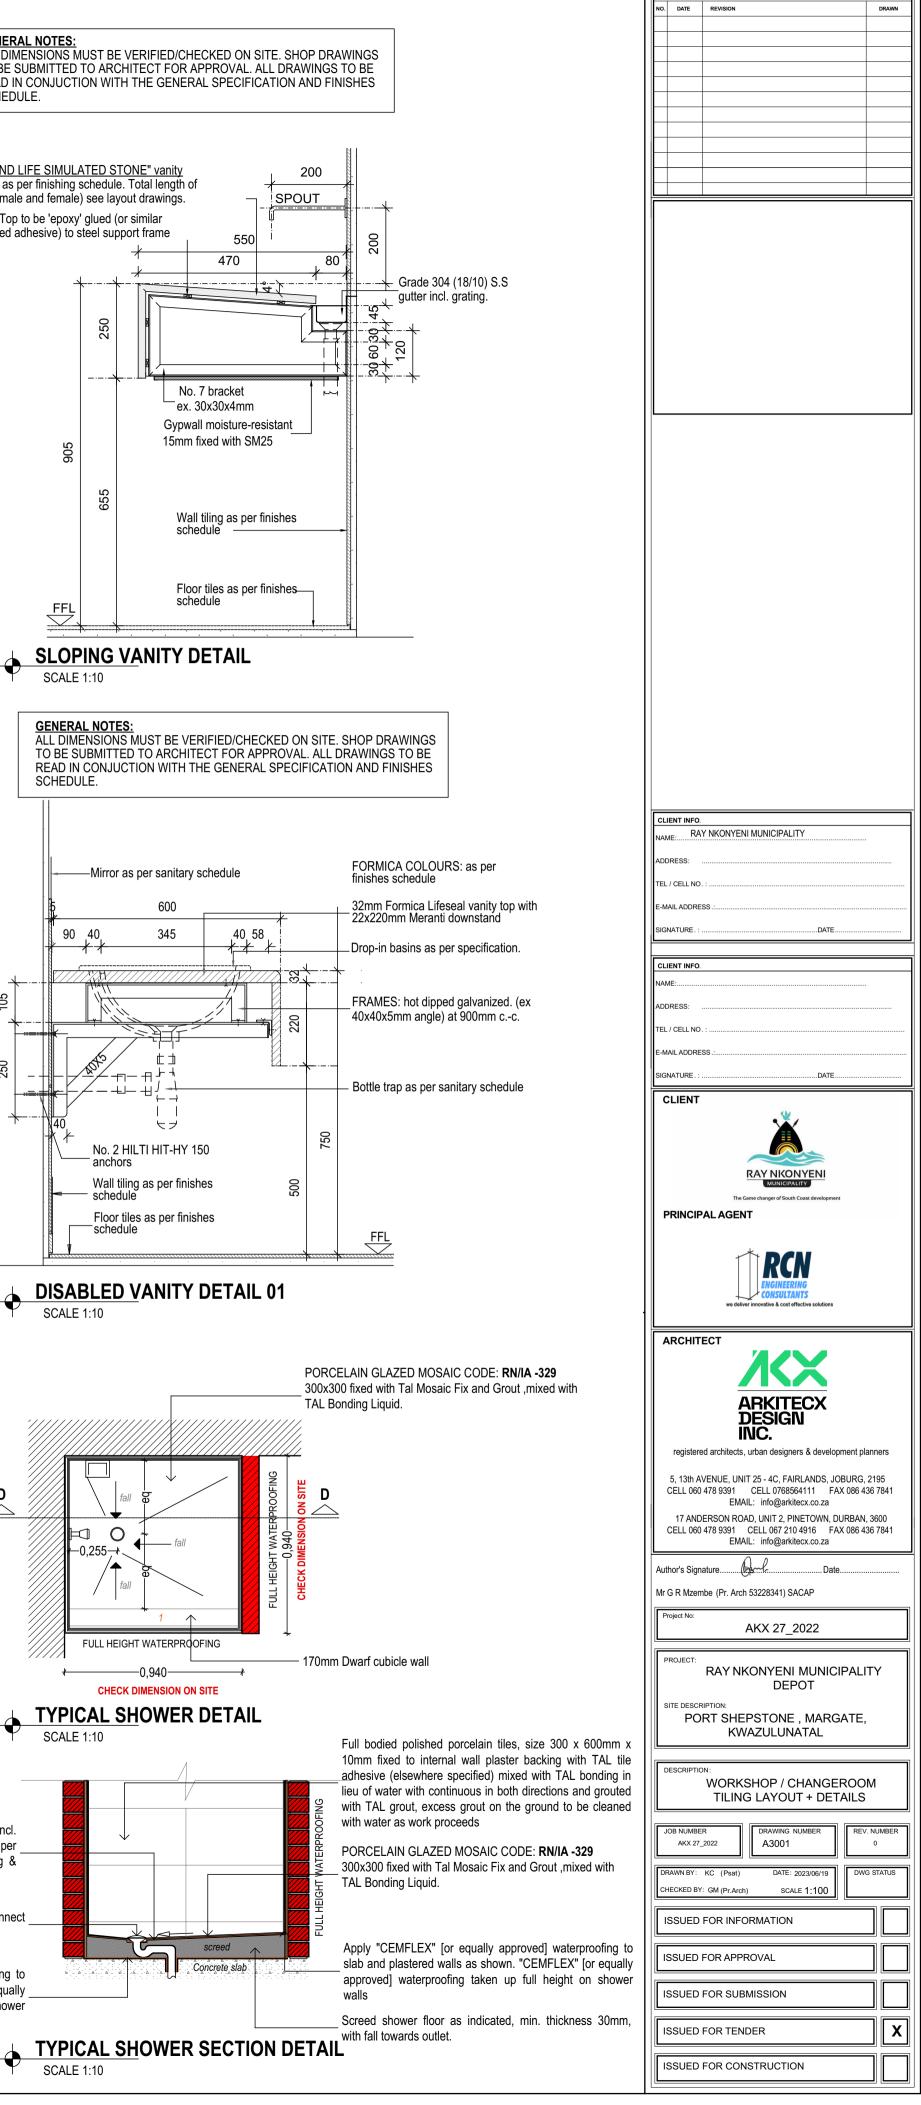

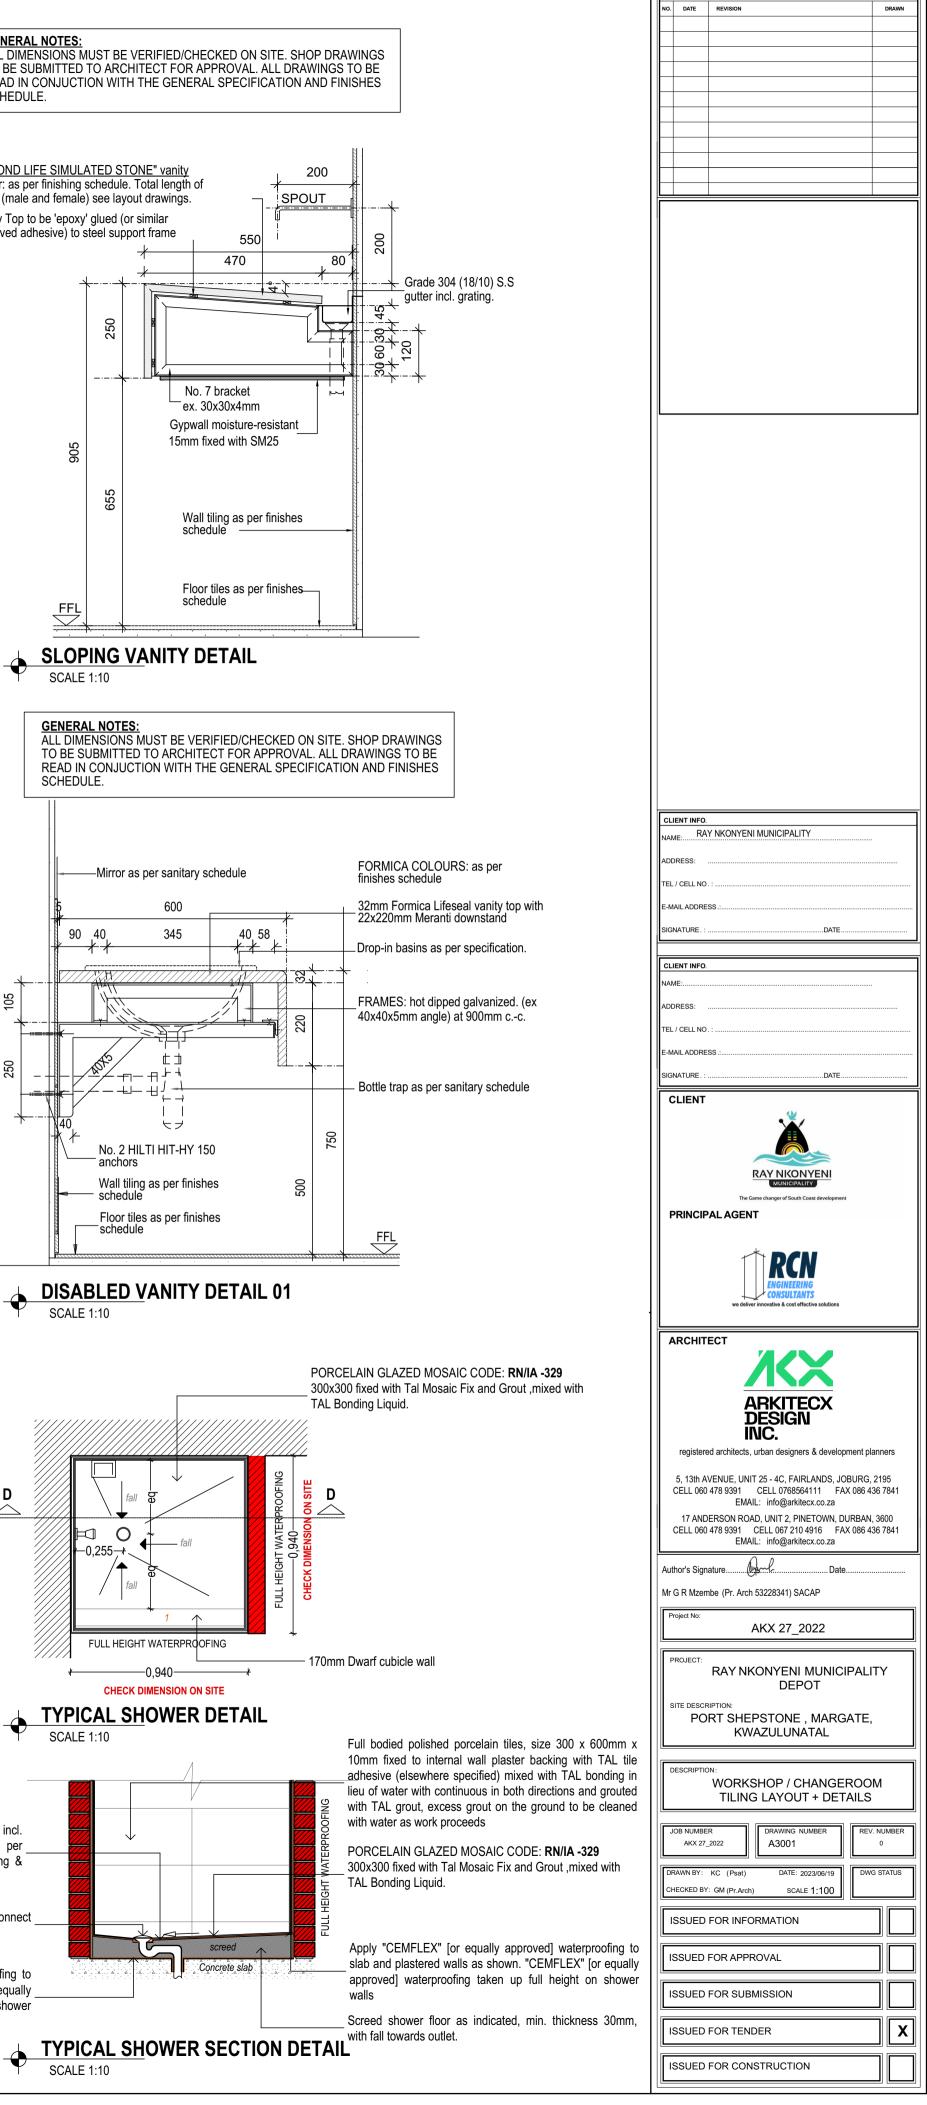

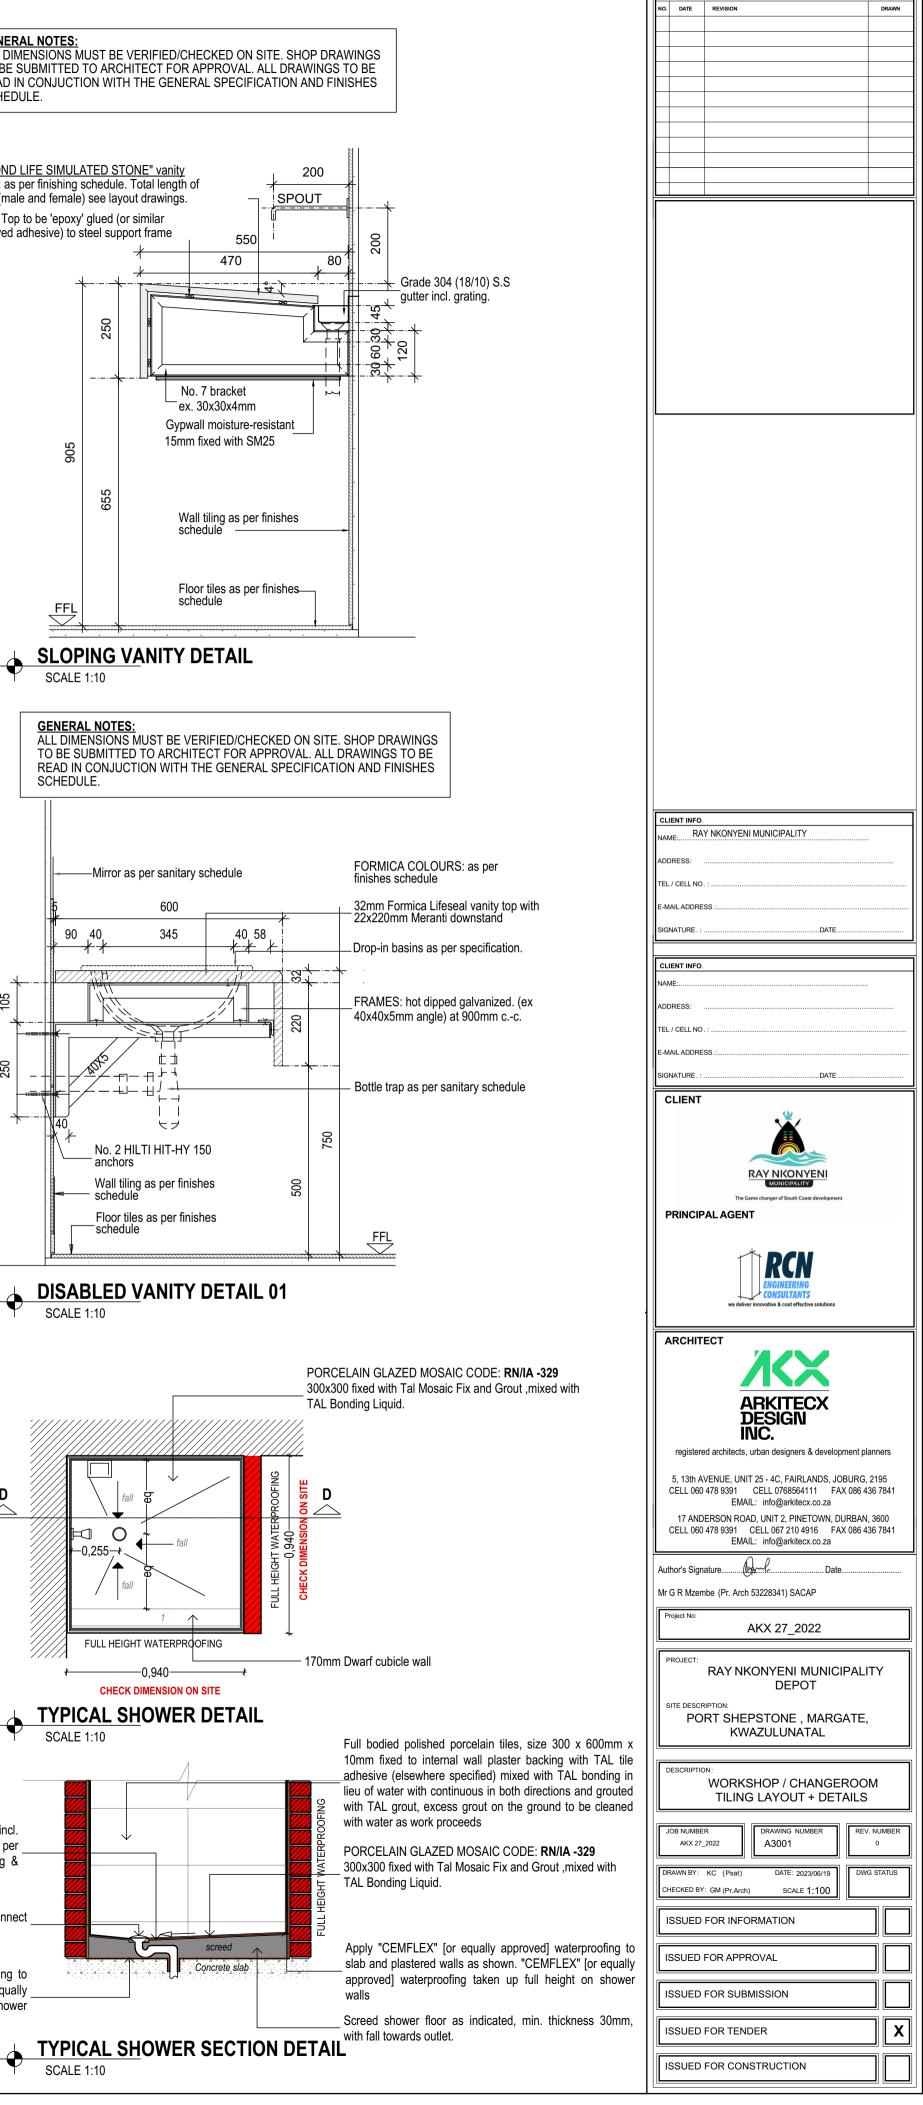

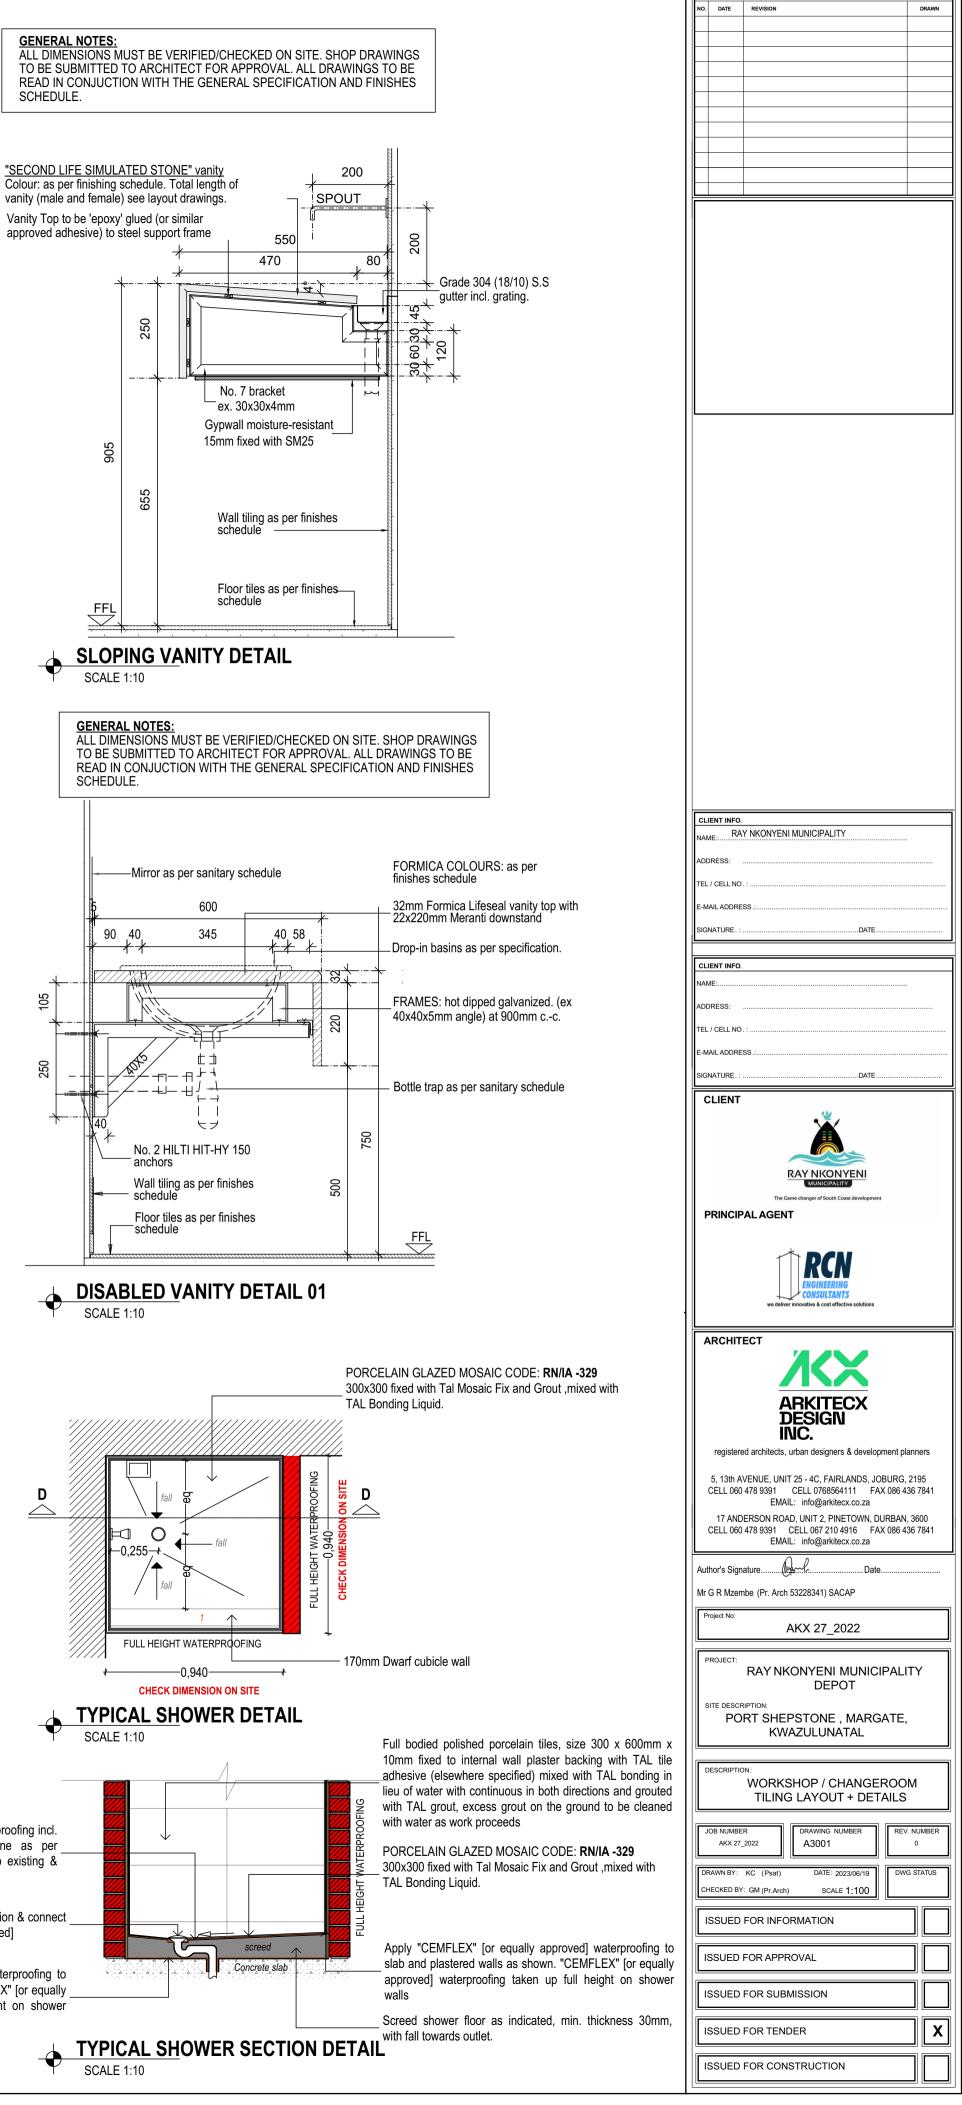

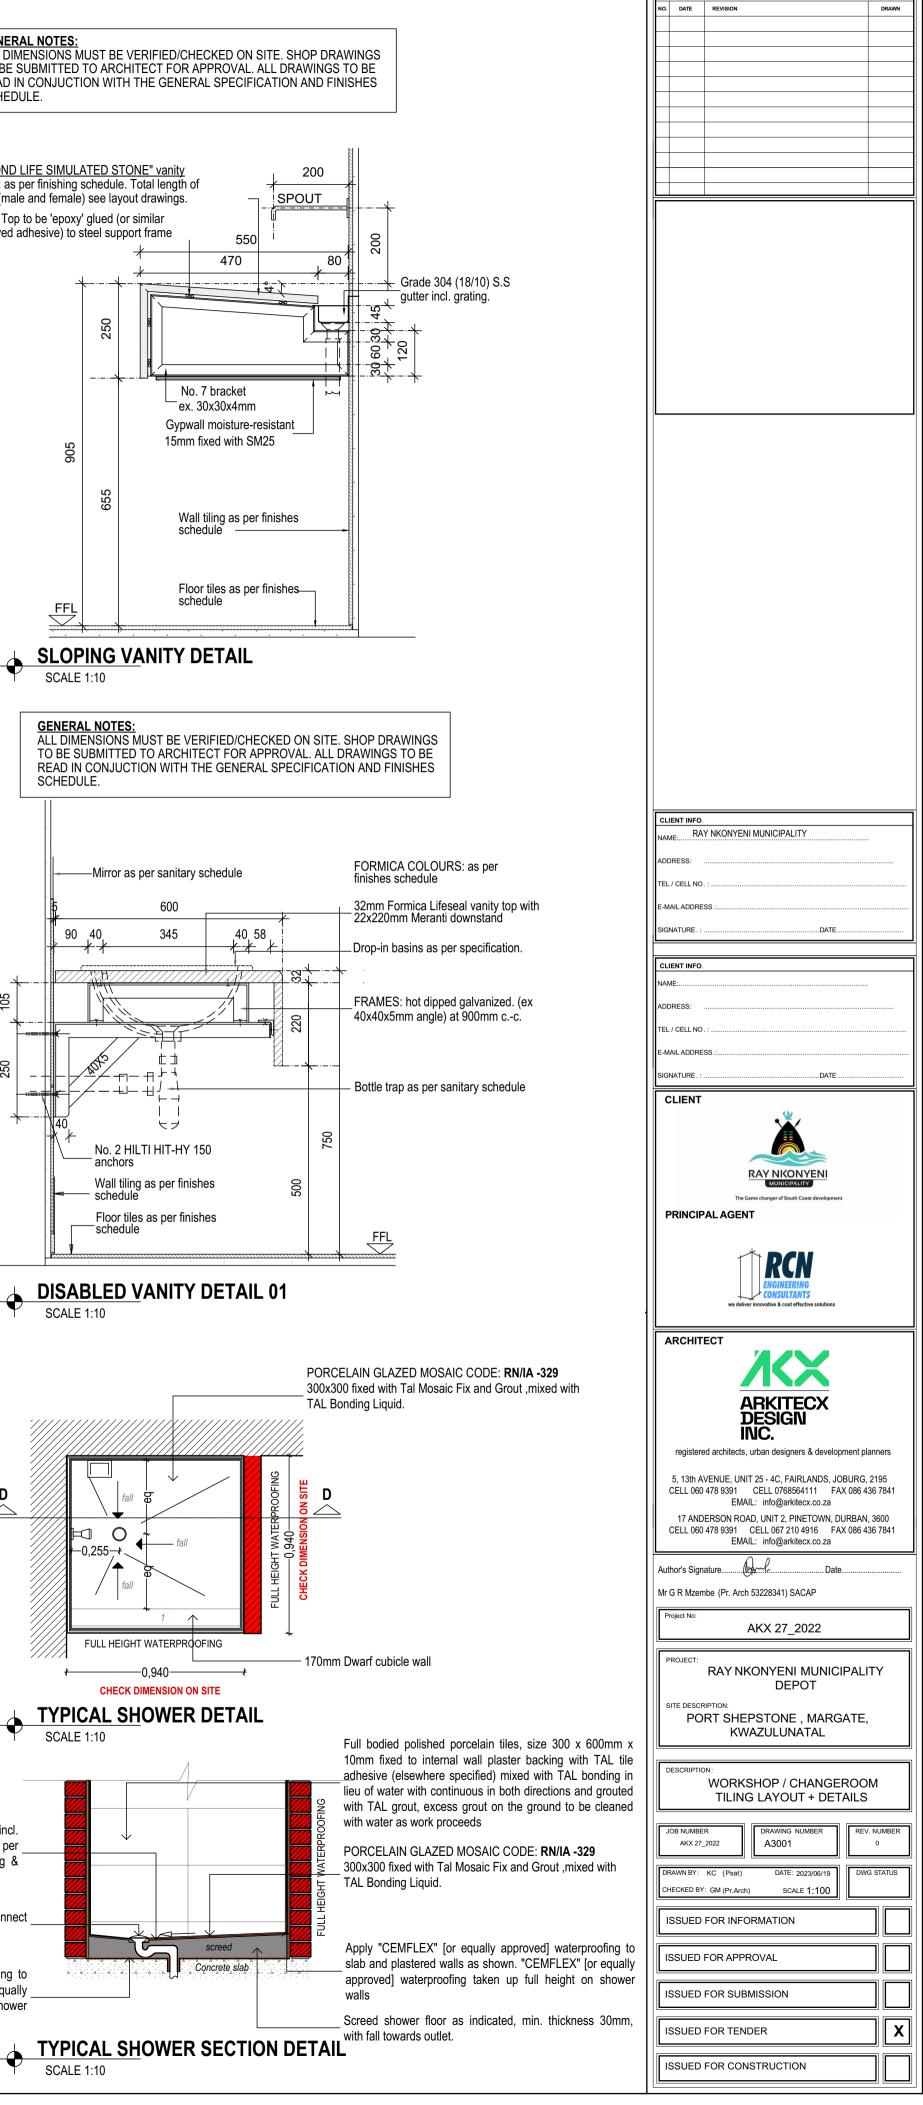

12.5mm Vinyl faced gypsum ceiling panels, face covered with white embossed vinyl, size 1200 x 600mm, laid on fire rated Cliq system S3 exposed demountable suspension system including galvanised main tees, cross tees, etc, All suspended with galvanised hangers at centres not exceeding 1200mm, with ceiling perimeter finished with shadowline W-trim plugged at 200mm centers and installed as per manufactures instructions.

Full bodied polished porcelain tiles, size 300 x 600mm x 10mm fixed to internal wall plaster backing with TAL tile adhesive (elsewhere specified) mixed with TAL bonding in lieu of water with continuous in both directions and grouted with TAL grout, excess grout on the ground to be cleaned with water as work proceeds

Vaal Sanitaryware Iceberg vitreous china drop-in vanity basin colour White (Code: 7034), size 420 x 420mm fitted into opening in granite vanity top (elsewhere specified) and sealed with silicone sealant where basin rim meets vanity top. To be used in conjunction with wall mounted push on demand tap as specified V05-V06.

Bathroom Butler Paraplegic Rails dog leg grab rail with 3 supports (code: GRDG03B) or equal approved with brushed grade 304 stainless steel finish, overall size 750 x 750mm, plugged and screwed to wall with stainless steel screws.


Vaal Sanitaryware Orchid Paraplegic vitreous china wall hung paraplegic back inlet washdown suite colour White, fixed on and including floor bracket (Code: 8082Z0) comprising 90° outlet open rim back inlet pan (Code: 439016) with exposed back inlet flushvalve (elsewhere specified) and Orchid double flap wooden seat (Code: 8520Z0).


Full bodied porcelain tiles, size 600 x 600mm x 10mm fixed to internal floor screed with TAL tile adhesive (elsewhere specified) mixed with TAL bonding in lieu of water with joints continuous in both directions and grouted with TAL grout, excess grout on the ground to be cleaned with water as work proceeds

Apply "CEMFLEX" [or equally approved] waterproofing incl. "CEMFLEX" [or equally approved] membrane as per Manufacturers specification to screed, overlap existing & dress around head of trap

Place "COBRA" 373SQ shower trap into position & connect to HDPE waste pipe [similar or equally approved]

Apply "CEMFLEX" [or equally approved] waterproofing to slab and plastered walls as shown. "CEMFLEX" for equally approved] waterproofing taken up full height on shower walls

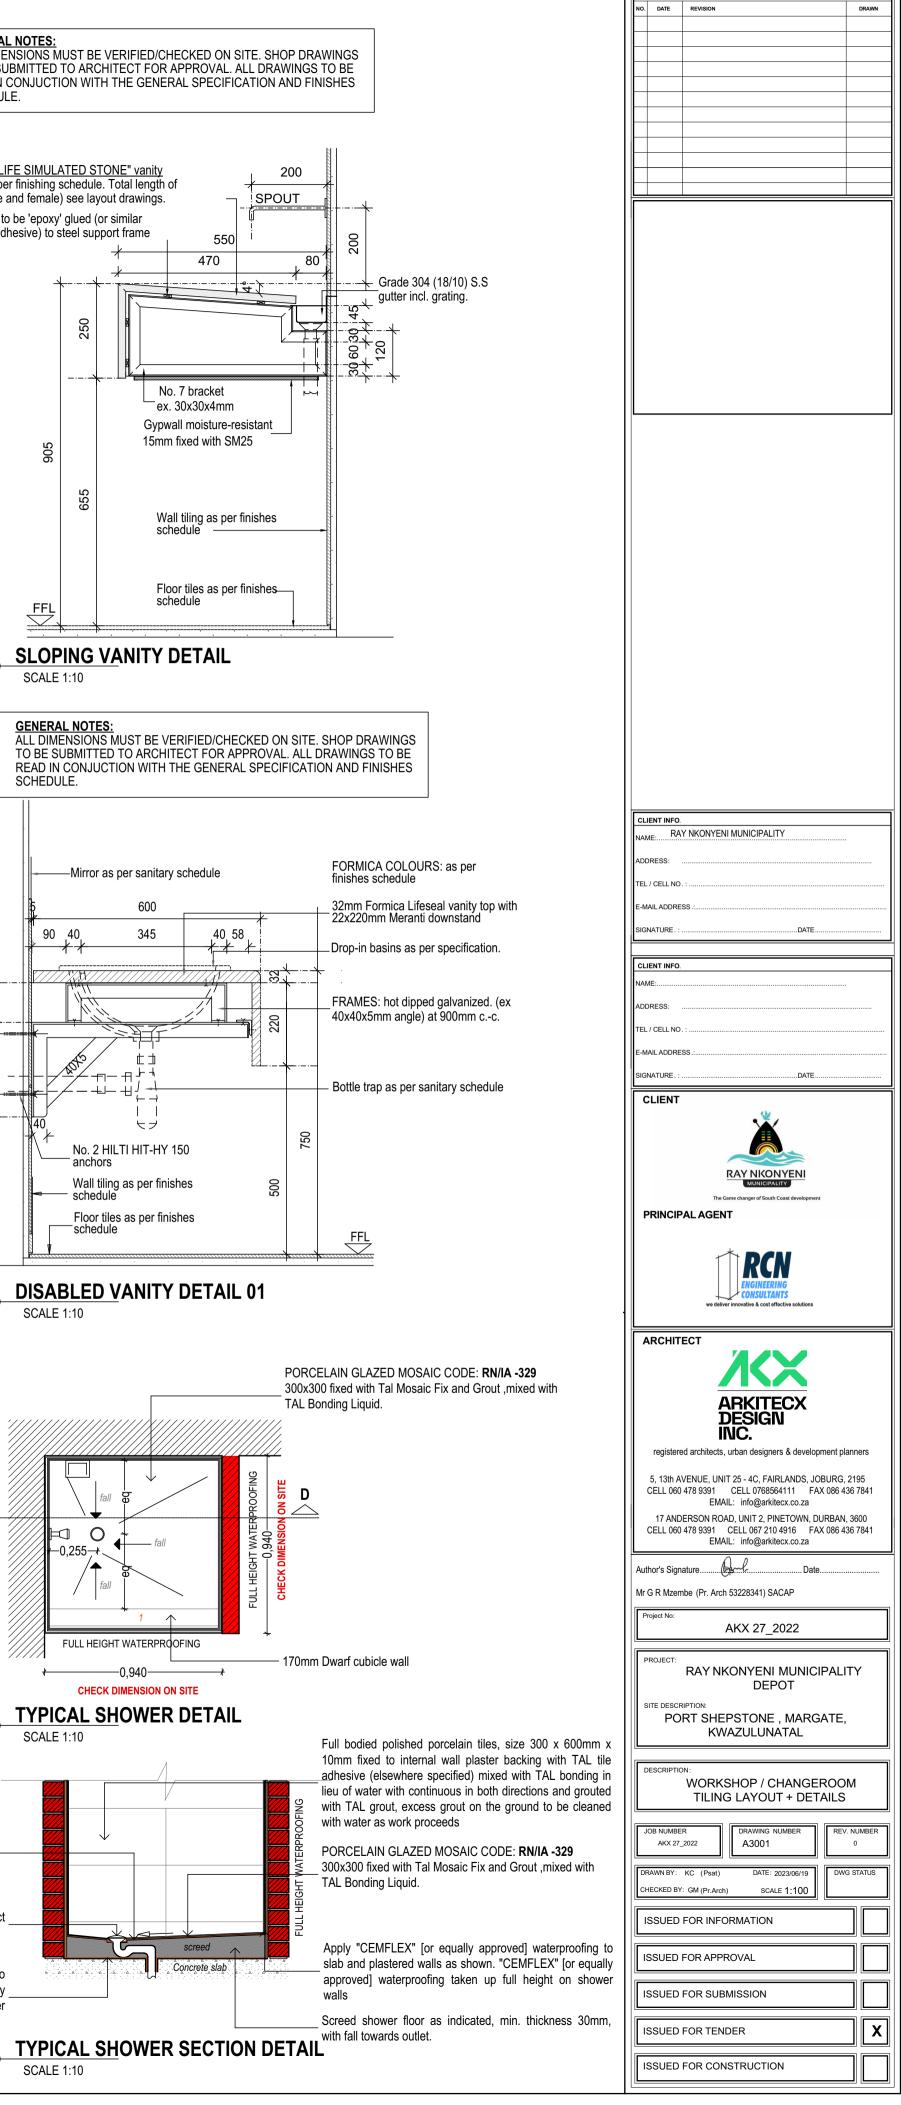


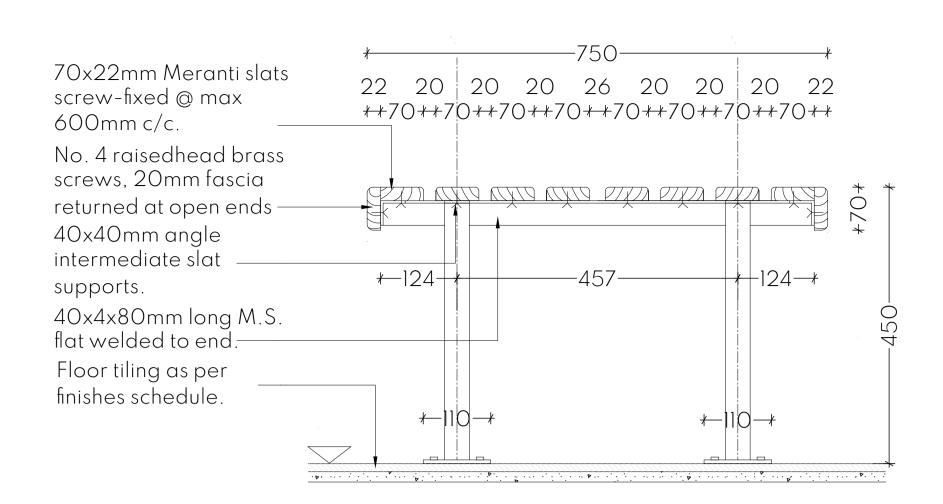

BENCH DETAIL

SCALE 1:5

WORKTOPS:	30MM RUSTENBURG POLISHED GRANITE WORKTOPS WITH 5MM DOUBLE BEVELLED EDGES	c)
CUPBOARD DOORS:	AMERICAN WALNUT MELAWOOD IMPACT DOORS WITH POST FORMED WRAPPED DOORS.		
STRUCTURE:	WHITE MELAMINE CARCASS BASE AND SHELVES WITH MASONITE BACKING AND BLACK PAINTED CHIPBOARD KICKPLATES AND MS POST SUPPORTS.		CUPBD
SINK:	1000 X 457MM STAINLESS STEEL DROP SINK		DOOR

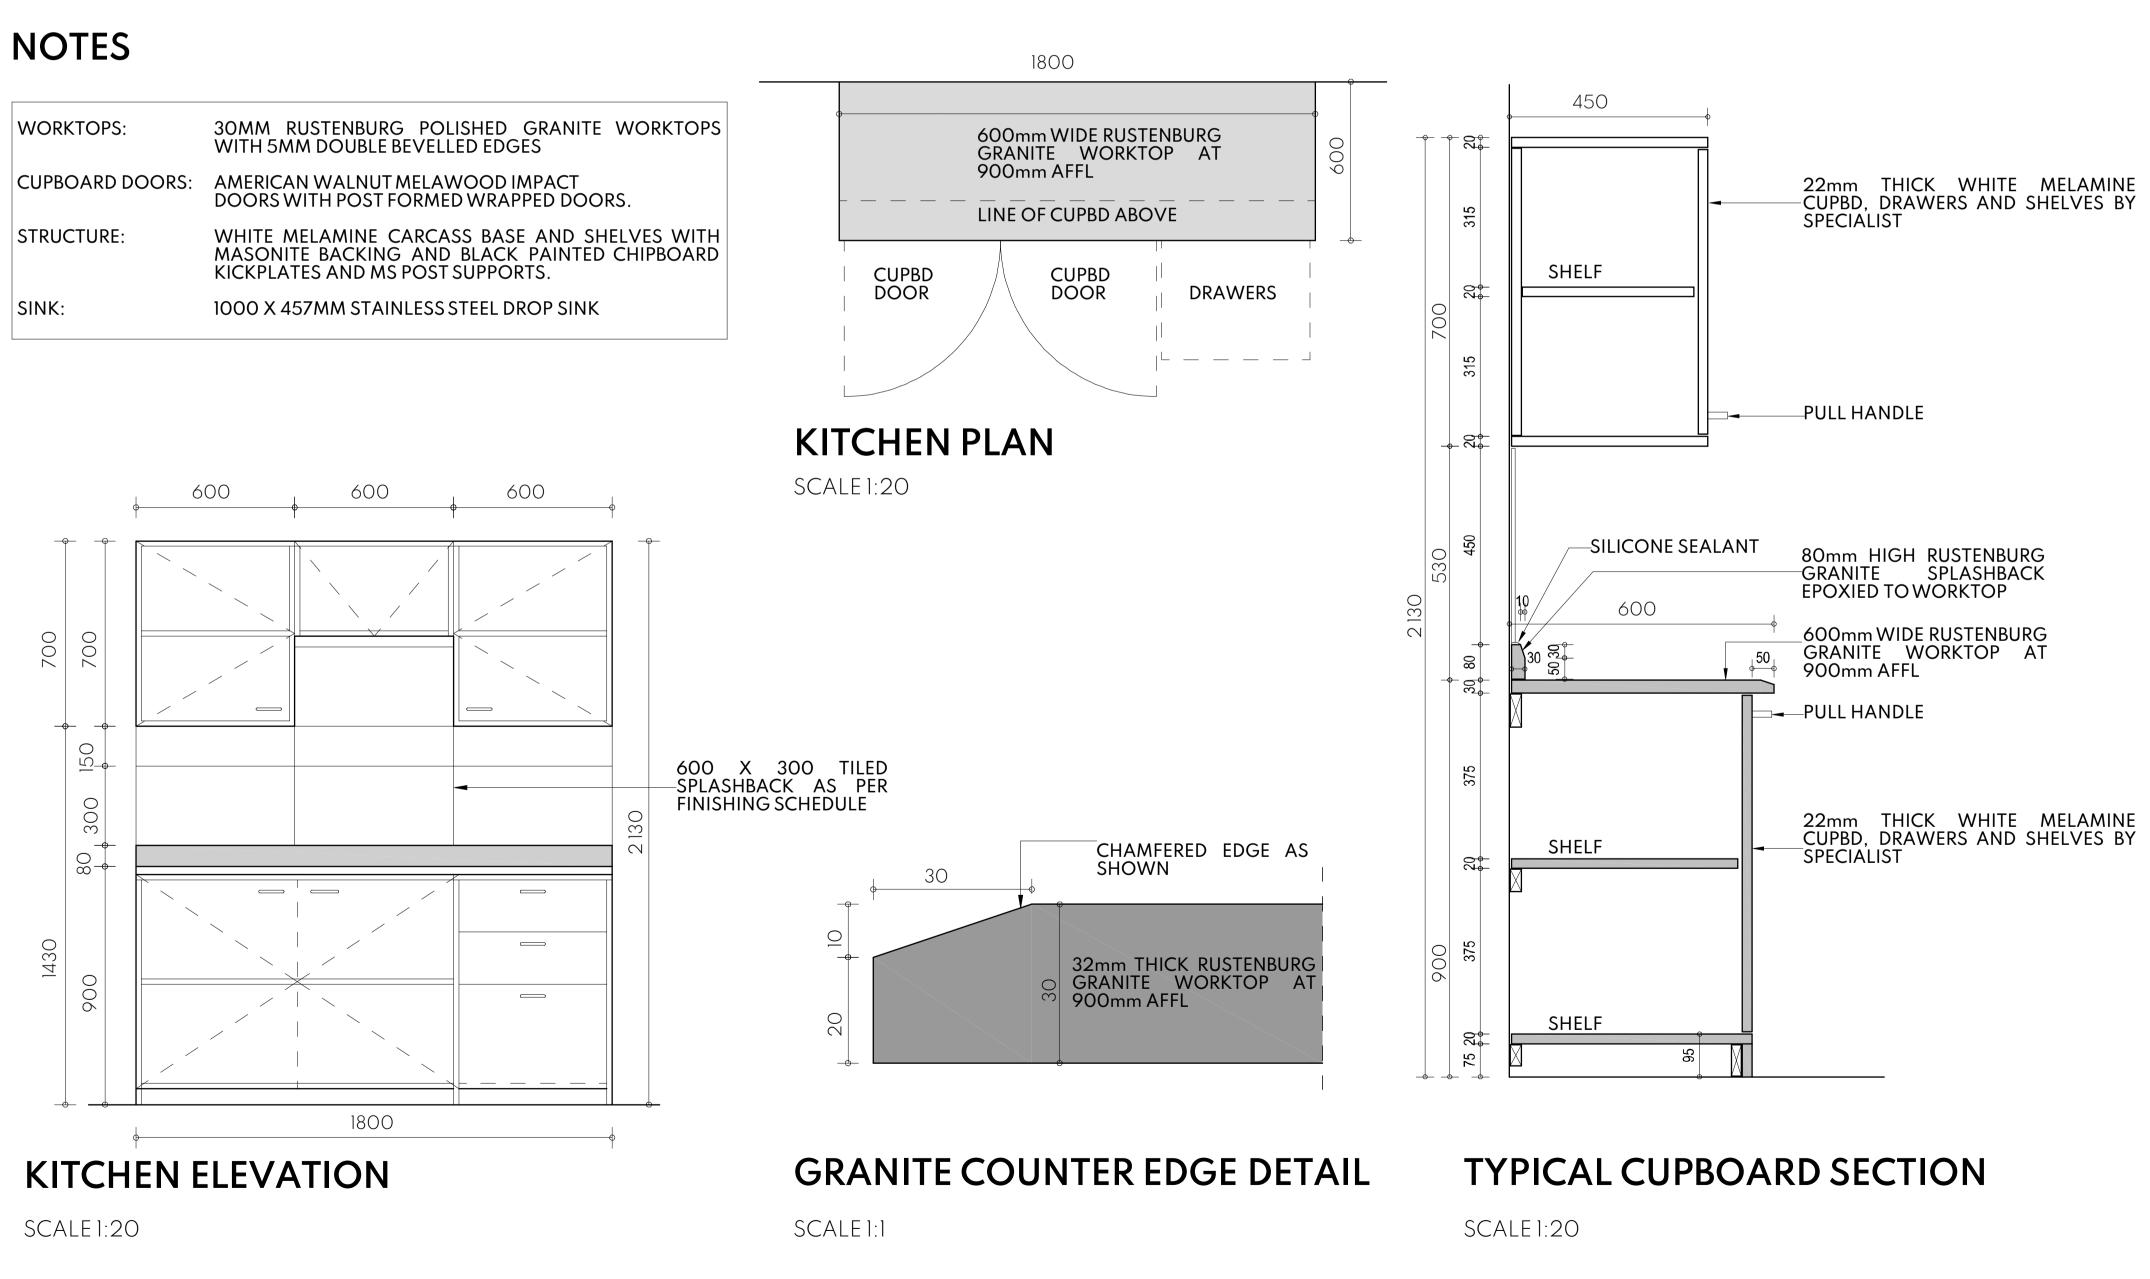


BUILDING CLASSIFICATION : H 4	REVISIONS
<u>COMPLIANCE IN RESPECT OF THE SOUTH AFRICAN NATIONAL</u>	REVISIONS NO. DATE REVISION DRAWN
BUILDING REGULATIONS AND BUILDIND STANDARDS ACT NO . 103 OF 1977	
PARTA : SANS10400- GENERAL PRINCIPLES & REQUIREMENTS	
 All requirements to comply with part A PART B : SANS10400- STRUCTURAL DESIGN All structural design if not designed by a competent person 	
shall comply with part B <u>PART C : SANS10400- DIMENSIONS</u>	
 All dimensions of any room or space to comply with requirements of part C 	
PART D : SANS10400- PUBLIC SAFETY All balustrades to comply with part D 4.2 and annex A(D1)	
PARTE : SANS10400- DEMOLISHED WORK All demolished to comply with part E	
PART F : SANS10400- SITE OPERATIONS All site operations to comply with part F	
PART G : SANS10400- EXCAVATIONS All excavations relating to building as per rational design by	
competent person to comply with part G 4.1 (b) <u>PARTH</u> : SANS10400- FOUNDATIONS	
 All foundations as per rational design by competent person to comply with part J 4.4.1(a) 	
 <u>PART K : SANS10400- WALLS</u> All masonry walls as per rational design by competent person to comply with annex (K1, K2, K3, and K4) 	
 All lintols as per rational design by competent person to comply with annex (B3) 	
 All waterproofing to comply with part annex K 4.5 7 annex (C1) All fire performance & resistance of all walls as per rational 	
design by competent person to comply with annex A (k4) <u>PARTL : SANS10400- ROOFS</u>	
 All roof assemblies to comply with part L 4.1 (a) All flat concrete roof structure as per rational design and cartification by competent parcent 	
 certification by competent person All roof covering and waterproofing to pitched roof to comply with part L4.5 	
 All roof structure as per rational design and certification by approved competent person 	
PART M : SANS10400- STAIRWAYS All stairways to comply with part M	
PART N : SANS10400- GLAZING All glazing to comply with part N 4.1, N4.2, N4.3 & N4.4	
 All glazing installations, windows systems and certification by approved competent person. 	
PART O : SANS10400- LIGHT AND VENTILLATION All light and ventilation in compliance with part 04.1 All areas to have natural light in compliance with part 04.2.1	
 All areas to have natural light in compliance with part 04.2.1 All areas to have natural ventilation in compliance with part 	
P4.3.1 <u>PARTP : SANS10400- DRAINAGE</u>	
 All drainage to comply with annex A (P1 & P2) All material, piles, fittings and joints to comply with part P 4.2 All contact for the second draw with next P 4.41 	
 All sanitary fixtures provided in compliance with part P 4.11 All sanitary ware fixtures provided in compliance with part P 4.3, P4.4 & P4.6 	
 All drainage system to comply with part P 4.13.2 All sizing of ventilation discharge pipes to comply with part 	CLIENT INFO. NAME: RAY NKONYENI MUNICIPALITY
 All sizing of ventilation discharge pipes to comply with part P4.14 All drain size shall comply with part P 4.15 	ADDRESS:
 All sanitary fixtures to be fitted with water seal traps in compliance with part P4.16 	TEL / CELL NO. :
 All sizing of ventilation pipe to comply with part P 4.17 All installations of discharge & ventilation pipes to be installed 	E-MAIL ADDRESS
in compliance with part P 4.18 All drainage installation to accessible in compliance with part	SIGNATURE. :
P4.19 All traps to be provided in compliance with part P 4.20	CLIENT INFO.
 All gullies provided in compliance with requirements of part P4.21 All drains to be laid in compliance with part D 4.22 & D4.22 	ADDRESS:
 All drains to be laid in compliance with part P 4.22 & P4.23 All drains exceeding gradients of 1.5 shall have anchor blocks 	TEL / CELL NO. :
provided in place in compliance with part P 4.22.4 (D) <u>PARTR: SANS10400- STORMWATER DISPOSAL</u>	E-MAIL ADDRESS
 All stormwater control and disposal to comply with part P 4.2 All sizes of roof valley & gutters as per rational design by competent person in compliance with part P 4.2 	CLIENT
 All stormwater drainage systems , layout and design as per rational design by competent person . 	×
 All installation and certifications thereof by approved registered competent plumbing specialist 	
PARTT : SANS10400- FIRE PROTECTION All materials to comply with part T 4.5	RAY NICONYENI MUNICIPALITY The Game changer of South Coast development
 All structural elements & components to comply with part T 4.7 Roof assemblies & covering to comply with part T 4.55 & T4.12 	PRINCIPAL AGENT
Building materials to comply with part T 4.55 & T4.56 PARTX : SANS10400- ENVIRONMENTAL SUSTAINABILITY & XA	
 <u>- ENERGY USAGE IN BUILDINGS</u> Environmental sustainability and energy usage to comply with 	
part X	we deliver innovative & cost effective solutions
	ARCHITECT
	ARKITECX
	DESIGN INC.
	registered architects, urban designers & development planners
	5, 13th AVENUE, UNIT 25 - 4C, FAIRLANDS, JOBURG, 2195 CELL 060 478 9391 CELL 0768564111 FAX 086 436 7841
	EMAIL: info@arkitecx.co.za 17 ANDERSON ROAD, UNIT 2, PINETOWN, DURBAN, 3600
	CELL 060 478 9391 CELL 067 210 4916 FAX 086 436 7841 EMAIL: info@arkitecx.co.za
	Author's Signature
	Mr G R Mzembe (Pr. Arch 53228341) SACAP
	AKX 27_2022
	PROJECT: RAY NKONYENI MUNICIPALITY
	DEPOT SITE DESCRIPTION:
	PORT SHEPSTONE , MARGATE, KWAZULUNATAL
	BENCH + KITCHEN DETAIL
	BENCH + KITCHEN DETAIL JOB NUMBER AKX 27_2022 DRAWING NUMBER A4001 DRAWN BY: KC DATE: 2023/06/19 DWG STATUS
	BENCH + KITCHEN DETAIL JOB NUMBER AKX 27_2022 DRAWING NUMBER AKX 27_2022 DRAWN BY: KC (Psat) DATE: 2023/06/19 CHECKED BY: GM (Pr.Arch) SCALE 1:100
	BENCH + KITCHEN DETAIL JOB NUMBER AKX 27_2022 DRAWING NUMBER A4001 DRAWN BY: KC DATE: 2023/06/19
	BENCH + KITCHEN DETAIL JOB NUMBER AKX 27_2022 DRAWING NUMBER AKX 27_2022 DRAWN BY: KC (Psat) DATE: 2023/06/19 CHECKED BY: GM (Pr.Arch) SCALE 1:100
	BENCH + KITCHEN DETAIL JOB NUMBER AKX 27_2022 DRAWING NUMBER AKX 27_2022 DRAWN BY: KC (Psat) DATE: 2023/06/19 CHECKED BY: GM (Pr.Arch) SCALE 1:100
	BENCH + KITCHEN DETAIL JOB NUMBER AKX 27_2022 DRAWING NUMBER AKX 27_2022 DRAWING NUMBER AKX 27_2022 DRAWING NUMBER O DRAWIN BY: KC (Psat) DATE: 2023/06/19 CHECKED BY: GM (Pr.Arch) SCALE 1:100 ISSUED FOR INFORMATION ISSUED FOR APPROVAL
	BENCH + KITCHEN DETAIL JOB NUMBER AKX 27_2022 DRAWING NUMBER AKX 27_2022 DRAWN BY: KC (Psat) DATE: 2023/06/19 CHECKED BY: GM (Pr.Arch) SCALE 1:100 ISSUED FOR INFORMATION ISSUED FOR APPROVAL ISSUED FOR SUBMISSION

W1					
WINDOWS (WINDOWS VIEWED EXTERNALLY) (WINDOWS VIEWED EXTERNALLY)					
Location Refer to plan					
CAT No: Purpose mad	e (W1)				
Qty 4	4				
Description CILL EXTERN CILL INTERN	00mm x 850mm Aluminium window lov AL: N/A AL : N/A	v E glazing			
Glazing 6.38mm Thic SANS 10400	k monolithic annealed safety glass to co	omply with part N of			
	Aluminium frame to be powder coated COLOUR: Charcoal Grey				
Sqm 2.7m ²					
ARCHITECT 5, 13th AVENUE, UNIT 25 - 4C, FAIRLANDS, JOBURG, 2195 17 ANDERSON ROAD, UNIT 2, PINETOWN, DURBAN, 3600	CLIENT PRINCIPAL AGENT	Project No: AKX 35_2022 Drawing Description:			
CELL 060 478 9391 / 0768564111 EMAIL: info@arkitecx.co.za	91 / 0768564111 INC. WINDOW SCHEDULE				
RAY NKONYENI MUNICIPALITY DEPOT X.J.M (C. Arch) G.R.M (Pr. Arch 53228341) SACAP 1:50 401					
SITE DESCRIPTION:	G.R.M (Pr. Arch)	Date: Rev: 19/06/2023 *			


	W2				
WINDOWS (WINDOWS VIEWED EXTERNALLY)		 0,500	2,400		
Location	Refer to plan				
CAT No:	Purpose mad	e (W2)			
Qty	9				
Description	Standard 27(CILL EXTERN CILL INTERN/	00mm x 3670m AL: N/A AL : N/A	m Aluminium windov	v low E glazing	9
Glazing	6.38mm Thic 10400	k monolithic anr	ealed safety glass to	comply with p	part N of SANS
Finishes	Aluminium fro	ame to be powd	er coated COLOUR:	Charcoal Grey	y
Sqm	1.2m²				
ARCHITECT 5, 13th AVENUE, UNIT 25 - 4C, FAIRLANDS, JOBURG, 2195 17 ANDERSON ROAD, UNIT 2, PINETOWN, DURBAN, 3600	ARKITECX DESIGN INC.		PRINCIPAL AGENT	Drawing Description:	AKX 35_2022
CELL 060 478 9391 / 0768564111 EMAIL: info@arkitecx.co.za PROJECT:	INC.	The Generation of South Coast development Drawn by:	we deliver innovative & cost effective solutions	Drawing Scale:	Drawing Number:
RAY NKONYENI MUNI DEPOT	CIPALITY	X.J.M (C. Arch)	G.R.M (Pr. Arch 53228341) SACAI	» 1:50	402
SITE DESCRIPTION:		Checked by: G.R.M (Pr. Arch)	Signed by:	Date: 19/06/2023	Rev: *

	W3			
WINDOWS (WINDOWS VIEWED EXTERNALLY)		+0'600*	<i>¥</i> —1,200 → <i>¥</i>	LL
Location	Refer to plan			
CAT No:	Purpose made	(W3)		
Qty	4			
Description	Standard 2700 CILL EXTERNA CILL INTERNAI	0mm x 1650mm L: N/A _ : N/A	Aluminium window low	v E glazing
Glazing	6.38mm Thick	monolithic anne	aled safety glass to cor	nply with part N of SANS 10400
Finishes	Aluminium frar	ne to be powde	r coated COLOUR: Cha	rcoal Grey
Sqm	0.72m ²			
ARCHITECT 5, 13th AVENUE, UNIT 25 - 4C, FAIRLANDS, JOBURG, 2195 17 ANDERSON ROAD, UNIT 2, PINETOWN, DURBAN, 3600	ARKITECX	CLIENT	PRINCIPAL AGENT	Project No: AKX 35_2022 Drawing Description:
CELL 060 478 9391 / 0768564111 EMAIL: info@arkitecx.co.za	ARKITECX DESIGN INC.	RAY NIKONYENI MURICIPATIAN The Gause changer of South Coast development	WiGHTMERFING CONSULTANTS we deliver innovative & cost effective solutions	WINDOW SCHEDULE
	PROJECT: Drawin by: Signed by: Drawing Scale: Drawing Number: RAY NKONYENI MUNICIPALITY DEPOT X.J.M (C. Arch) G.R.M (Pr. Arch 53228341) SACAP 1:50 403			
SITE DESCRIPTION:		Checked by: G.R.M (Pr. Arch)	Signed by:	Date: Rev: 19/06/2023 *


	W4			
WINDOWS (WINDOWS VIEWED EXTERNALLY)			+−0,900-+ 009'0+ 	LL FFL FFL FFL FFL FC FC FC FDC SCALE1:50
Location	Refer to plan			
CAT No:	Purpose made	(W4)		
Qty	3			
Description	Standard 1500 CILL EXTERNA CILL INTERNA	0mm x 2000mm L: Brick on edge L : Fibre cement	a Aluminium window lov cill,(painted)	w E glazing
Glazing	4mm Thick mc SANS 10400	nolithic anneale	ed safety glass to compl	y with part N of
Finishes		me to be powde	r coated COLOUR: Cha	ircoal Grey
Sqm	0.54m ²			
ARCHITECT 5, 13th AVENUE, UNIT 25 - 4C, FAIRLANDS, JOBURG, 2195	ЖX		PRINCIPAL AGENT	Project No: AKX 35_2022
17 ANDERSON ROAD, UNIT 2, PINETOWN, DURBAN, 3600 CELL 060 478 9391 / 0768564111 EMAIL: info@arkitecx.co.za	ARKITECX DESIGN INC.	RAY NKONYENI MUNICIPALITY The Gase dianger of South Cases divergingment	we deliver innovative & cost effective solutions	Drawing Description: WINDOW SCHEDULE
PROJECT: RAY NKONYENI M DEPC		Drawn by: X.J.M (C. Arch)	Signed by: G.R.M (Pr. Arch 53228341) SACAP	Drawing Scale: Drawing Number: 1:50 403
SITE DESCRIPTION:	~ •	Checked by: G.R.M (Pr. Arch)	Signed by:	Date: Rev: 19/06/2023 *

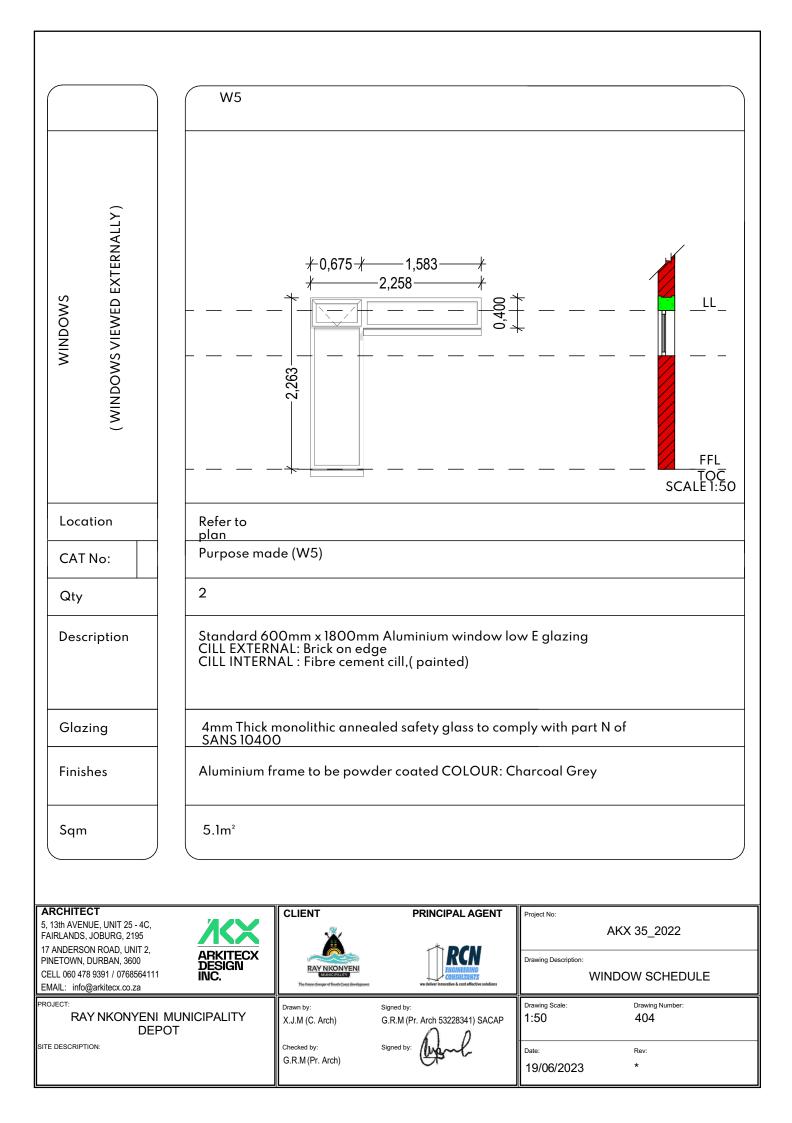



	W6				
WINDOWS (WINDOWS VIEWED EXTERNALLY)		+ 0,600	╗		FFL TOC SCALE1:50
Location	Refer to plan				
CAT No:	Purpose made	e (W6)			
Qty	25				
Description	Standard 600 CILL EXTERNA CILL INTERNA	0mm x 600mm / AL: Brick on edg L : Fibre cemen	Aluminium window low e t cill,(painted)	E glazing	
Glazing	4mm Thick me SANS 10400	onolithic anneal	ed safety glass to comp	bly with part N of	
Finishes	Aluminium fra	me to be powd	er coated COLOUR: Ch	arcoal Grey	
Sqm	0.36m²				
ARCHITECT 5, 13th AVENUE, UNIT 25 - 4C, FAIRLANDS, JOBURG, 2195 17 ANDERSON ROAD, UNIT 2, PINETOWN, DURBAN, 3600 CELL 060 478 9391 / 0768564111 EMAIL: info@arkitecx.co.za	ARKITECX DESIGN INC.	CLIENT CL	PRINCIPAL AGENT	Project No: AKX 35_ Drawing Description: WINDOW S	
PROJECT: RAY NKONYENI N DEPC SITE DESCRIPTION:		Drawn by: X.J.M (C. Arch) Checked by: G.R.M (Pr. Arch)	Signed by: G.R.M (Pr. Arch 53228341) SACAP Signed by:	Drawing Scale: Drawing 1:50 405 Date: Rev: 19/06/2023 *	ng Number: 5

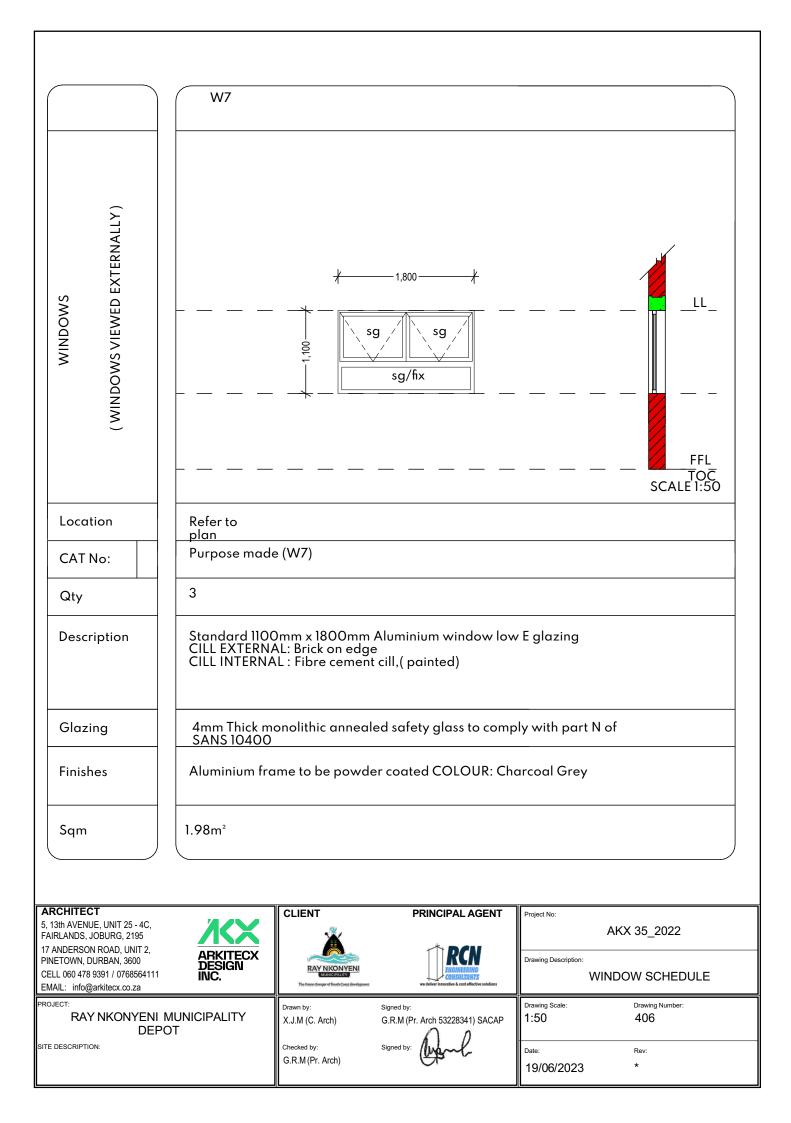



	W8			
WINDOWS (WINDOWS VIEWED EXTERNALLY)			2,370 	
Location	Refer to plan	(1110)		
CAT No:	Purpose made	(W8)		
Qty	9			
Description	Standard 400 CILL EXTERNA CILL INTERNA	mm x 2370mm L: Brick on edge L : Fibre cement	Aluminium window low e t cill,(painted)	v E glazing
Glazing	4mm Thick mc SANS 10400	onolithic anneal	ed safety glass to comp	oly with part N of
Finishes	Aluminium fra	me to be powde	er coated COLOUR: Ch	arcoal Grey
Sqm	0.95m ²			
ARCHITECT		CLIENT	PRINCIPAL AGENT	
5, 13th AVENUE, UNIT 25 - 4C, FAIRLANDS, JOBURG, 2195 17 ANDERSON ROAD, UNIT 2, PINETOWN, DURBAN, 3600				Project No: AKX 35_2022
CELL 060 478 9391 / 0768564111 EMAIL: info@arkitecx.co.za	ARKITECX DESIGN INC.	RAY NKONYENI MUNICIPALITY The Game changer of South Cases development	we deliver innovative & cellscolers	DOOR SCHEDULE
RAY NKONYENI M DEPC		Drawn by: X.J.M (C. Arch)	Signed by: G.R.M (Pr. Arch 53228341) SACAP	Drawing Scale: Drawing Number: 1:50 407
ITE DESCRIPTION:		Checked by: G.R.M (Pr. Arch)	Signed by:	Date: Rev: 28/04/2023 *

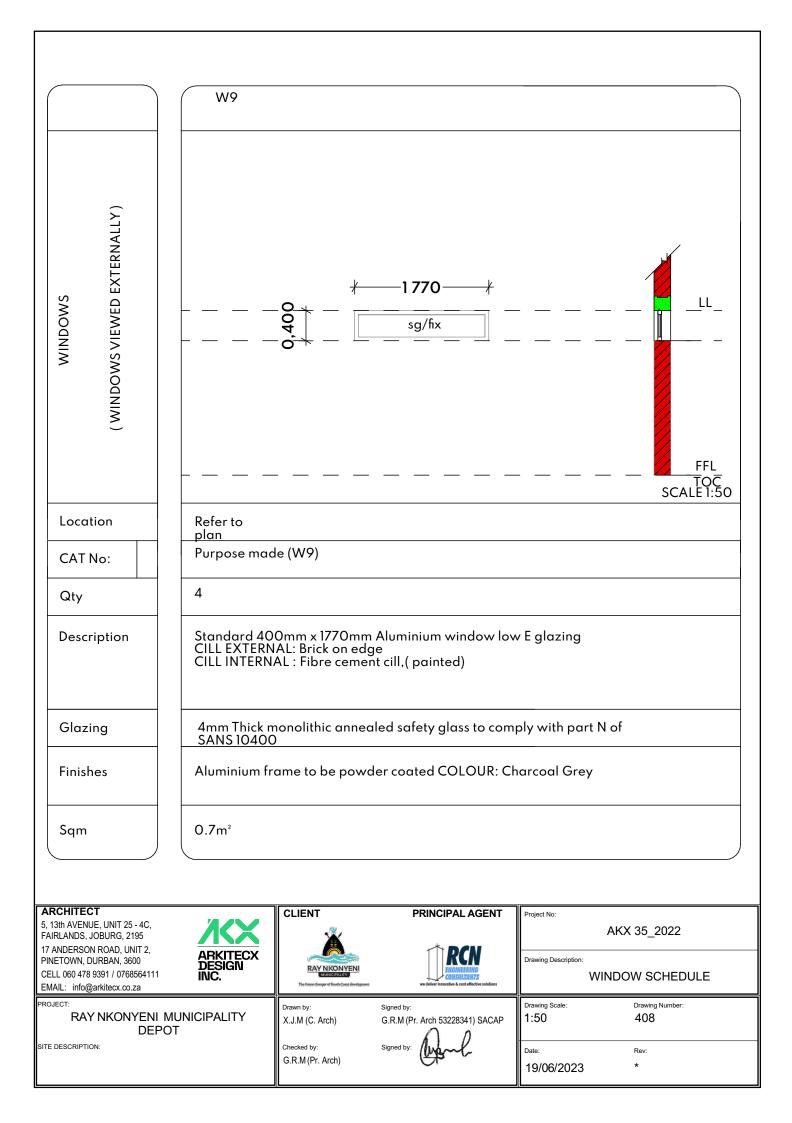


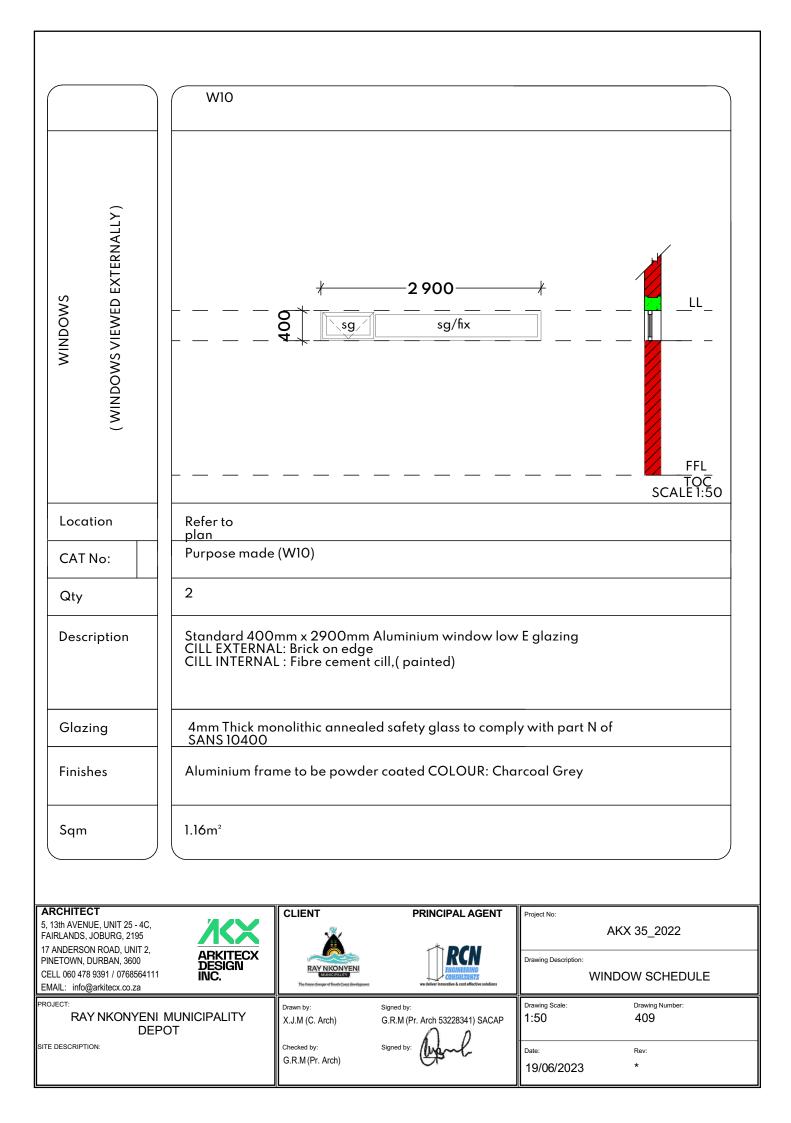


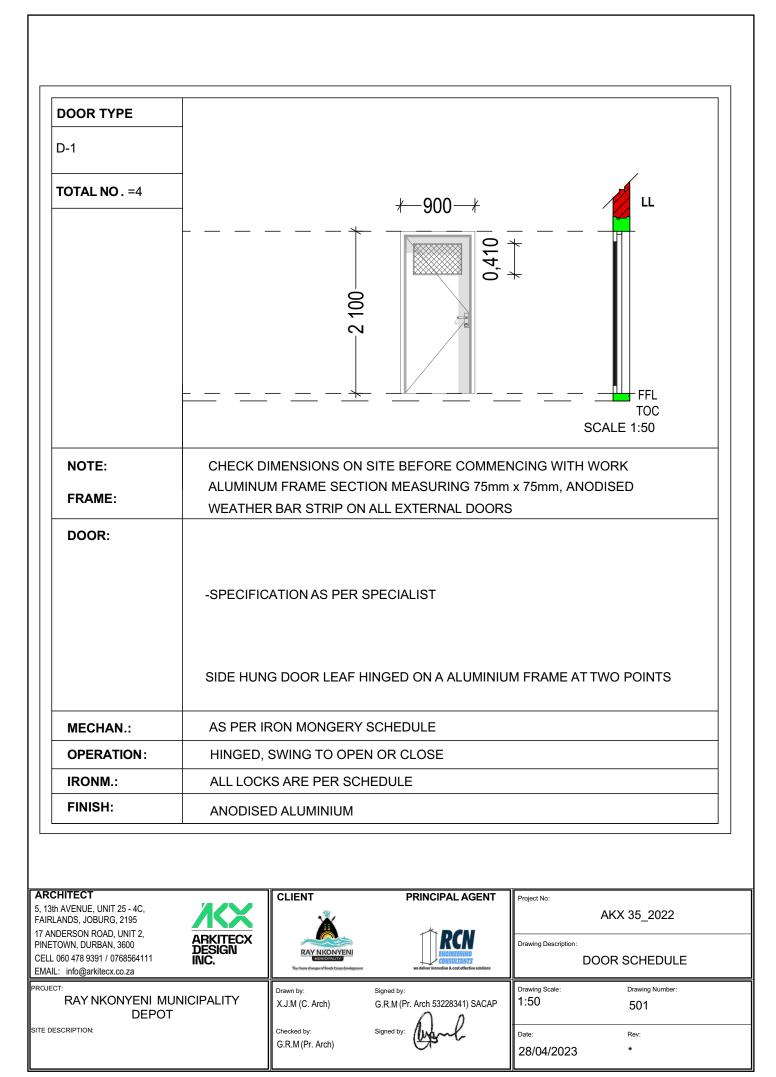


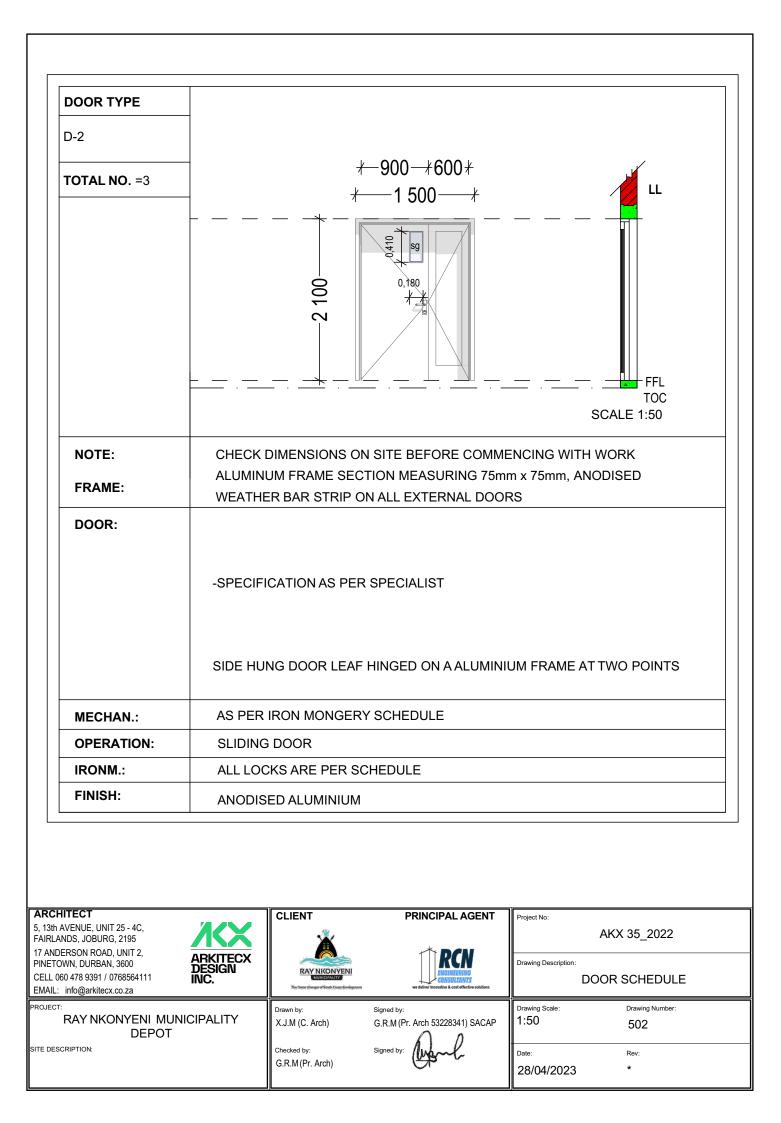

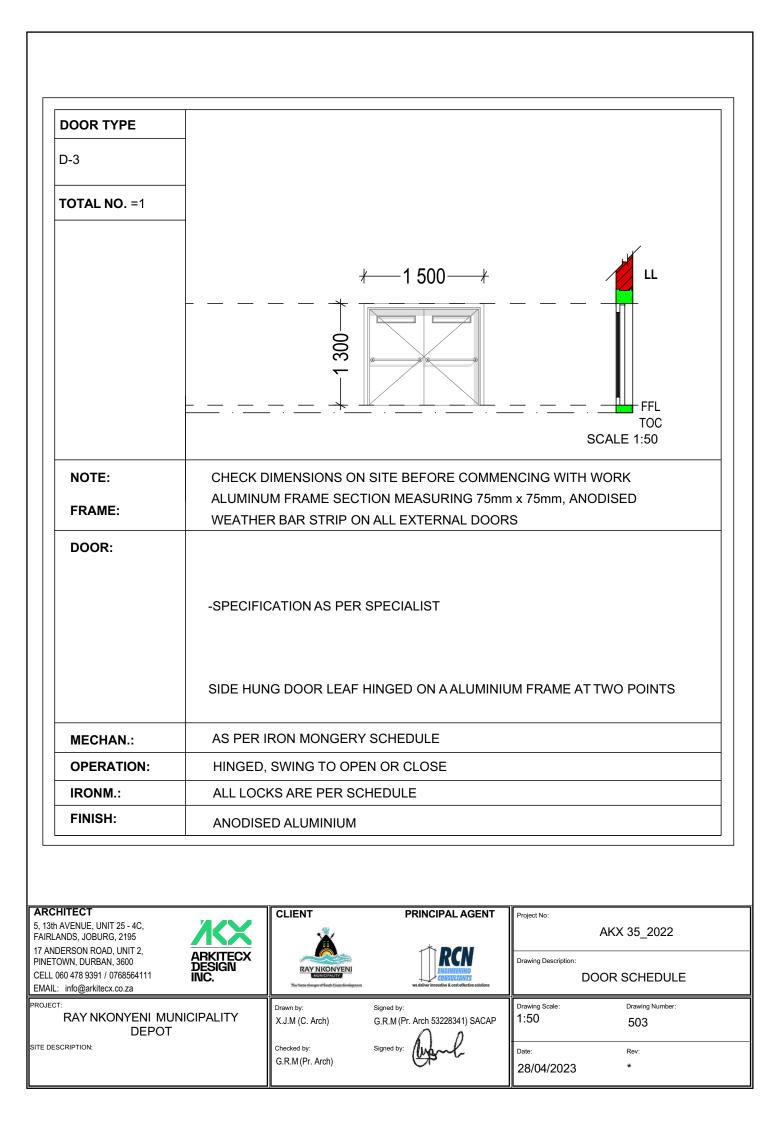

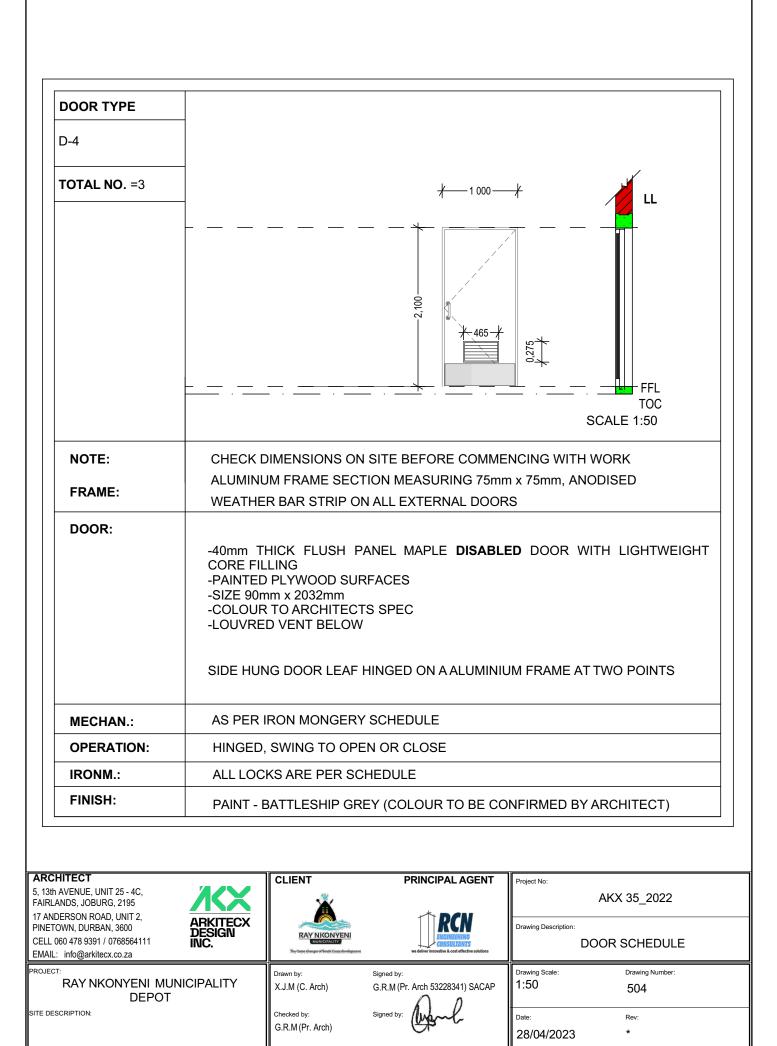

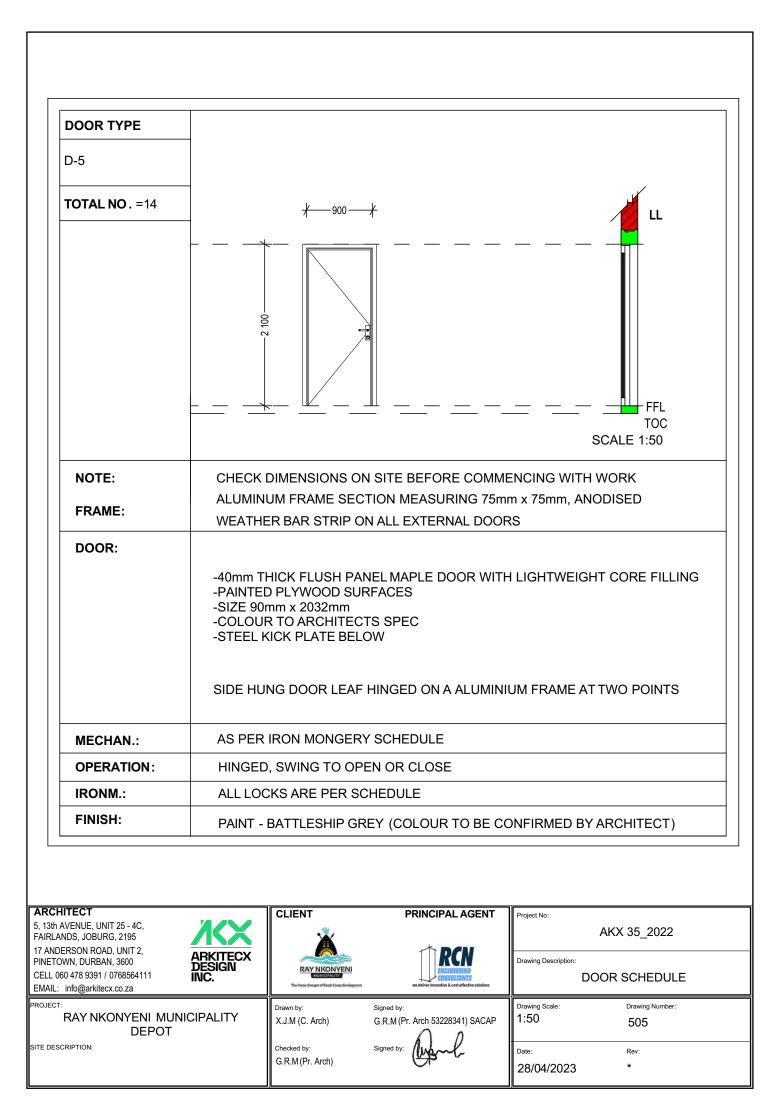

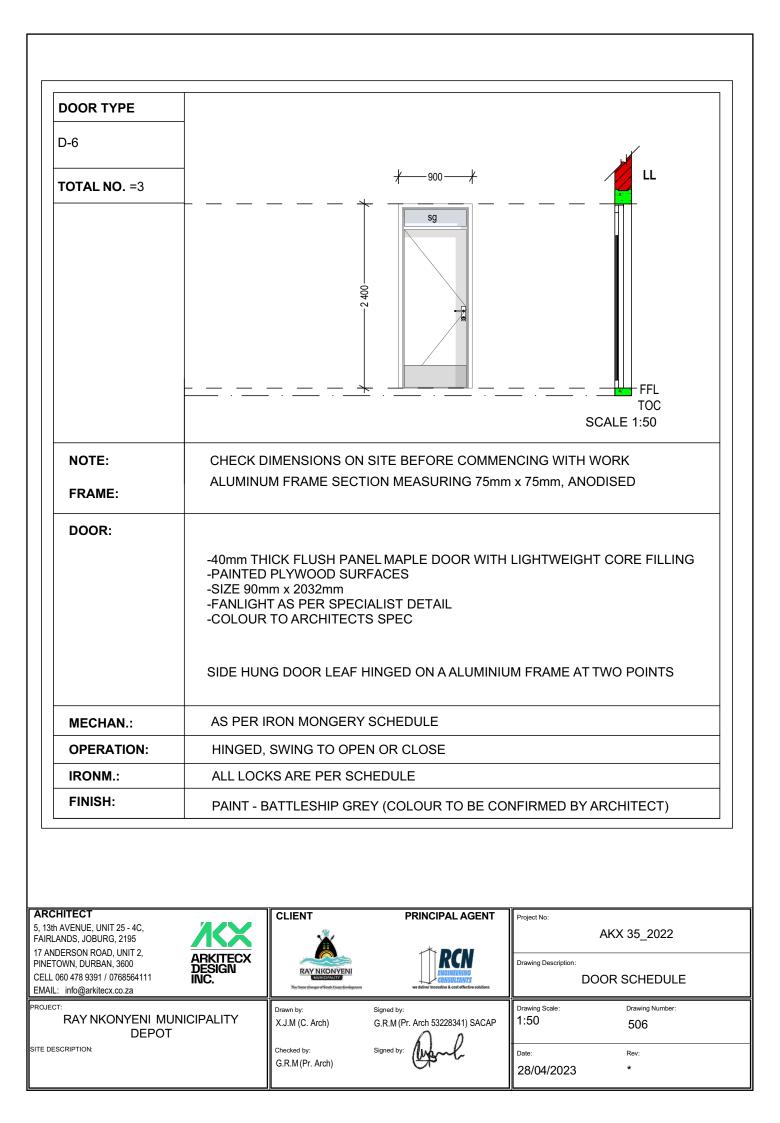

DOOR TYPE	ELECTRONIC METER REDUCTION GEAR BOX	
RSD1		
TOTAL NO. = 1	4 4500	
	<u>↓</u> <u></u>	_
NOTE:	CHECK DIMENSIONS ON SITE BEFORE COMMENCING WITH WORK	
FRAME:	ROLL-UP SEE-THRU GALVANISED & EPOXY COATED M/S PERFORATED ROLLER SHUTTER FOR OPENINGS 7.6M HIGH, ELECTRICALLY OPERATED WITH 380 VOLT HEAVY DUTY MOTOR (TO MATCH DOOR SIZE AND USAGE MANUAL OVERRIDE, WITH 75 X 1.0MM THICK GALV. ENDLOCKED SLATS COMPLETE WITH DOUBLE BELL MOUT WINDLOCKED GUIDES, POWDER COATED ANCILLARY COMPONENTS INCL DOOR CURTAIN, 4.5MM THICK END F GUIDE RAILS, CLOSED SHAFT, EXTRUDED ALUMINIUM T-BAR WITH ASTRAGAL RUBBER WEATHER SEALAND S SPAN GALV, COVER BOX, OPERATED WITH HIGH SECURITY KEY SWITCH, FIXED TO BRICK, CONCRE' STRUCTURAL STEEL JAMBS AND STRUCTURAL STEEL BEAM OVER, CONTRACTOR TO PROVIDE CAVITY 16 120MM FOR RECESSING GUIDES) WITI [H, M/ PLATE SINGLI TE OI
DOOR:	-ROLL-UP SERANDA OR SIMILAR APPROVED ROLLER SHUTTER TO BE INSTALLED BY A SPECIALIST APPROVE THE MANUFACTURER, ELECTRICAALLY OPERATED DOORS ARE TO BE FITTED WITH UP AND DOWN I SWITCHES, ELECTRO MAGNETIC OR FICTION BRAKES, THERMAL OVERLOAD CUTOUT AND CHAIN OR HAND C EMERGENCY OPERATION AND SAFETY BOTTOM RAIL WITH PNEUMATICALLY OPERATED AUTOMATIC REVERS LIGHT BEAM CONTROLLED AUTOMATIC REVERSE, POWDER COATED "MATT DARK UMBER GREY" FINISH	LIGHT RANK
OPERATION:	ELECTRICALLY OPERATED WITH 380 VOLT HEAVY DUTY MOTOR (TO MATCH DOOR SIZE AND USAGE) WITH I OVERIDE	MANU
IRONM.:	SIDE LOCKS AS SUPPLIED BY MANUFACTURER AND APPROVED BY ARCHITECT	

	CLIENT	PRINCIPAL AGENT	Project No:	
5, 13th AVENUE, UNIT 25 - 4C, FAIRLANDS, JOBURG, 2195	*		,	AKX 35_2022
17 ANDERSON ROAD, UNIT 2, PINETOWN, DURBAN, 3600		RCN	Drawing Description:	
CELL 060 478 9391 / 0768564111 INC.	MUNICIPALITY The Game changer of South Coast development	CONSULTANTS we deliver innovative & cost effective solutions	DO	OR SCHEDULE
EMAIL: info@arkitecx.co.za	The case comprise control of the case of the print	We deriver initialized a cost effective soletions		
PROJECT:	Drawn by:	Signed by:	Drawing Scale:	Drawing Number:
RAY NKONYENI MUNICIPALITY	Drawn by: X.J.M (C. Arch)		Drawing Scale: 1:50	Drawing Number: 507
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